PHASE 2 - HISTORIC STABILIZATION

BANDERA COUNTY VISITOR CENTER

100% CONSTRUCTION DOCUMENT



www.banderacounty.org

BANDERA COUNTY 500 MAIN STREET BANDERA, TX 78003 CONTACTS: HONORABLE JUDGE RICHARD EVANS COMMISSIONER JACK MOSELEY EMAIL: countyjudge@banderacounty.org jmoseley@banderacounty.org PH: JACK MOSELEY - (830) 522-1500


FISHER HECK ARCHITECTS 915 S. ST. MARY'S STREET SAN ANTONIO, TX 78205 PH: (210) 299-1500 CONTACT: MARK NAVARRO EMAIL: mnavarro@fisherheck.com www.fisherheck.com


BANDERA COUNTY VISITOR CENTER

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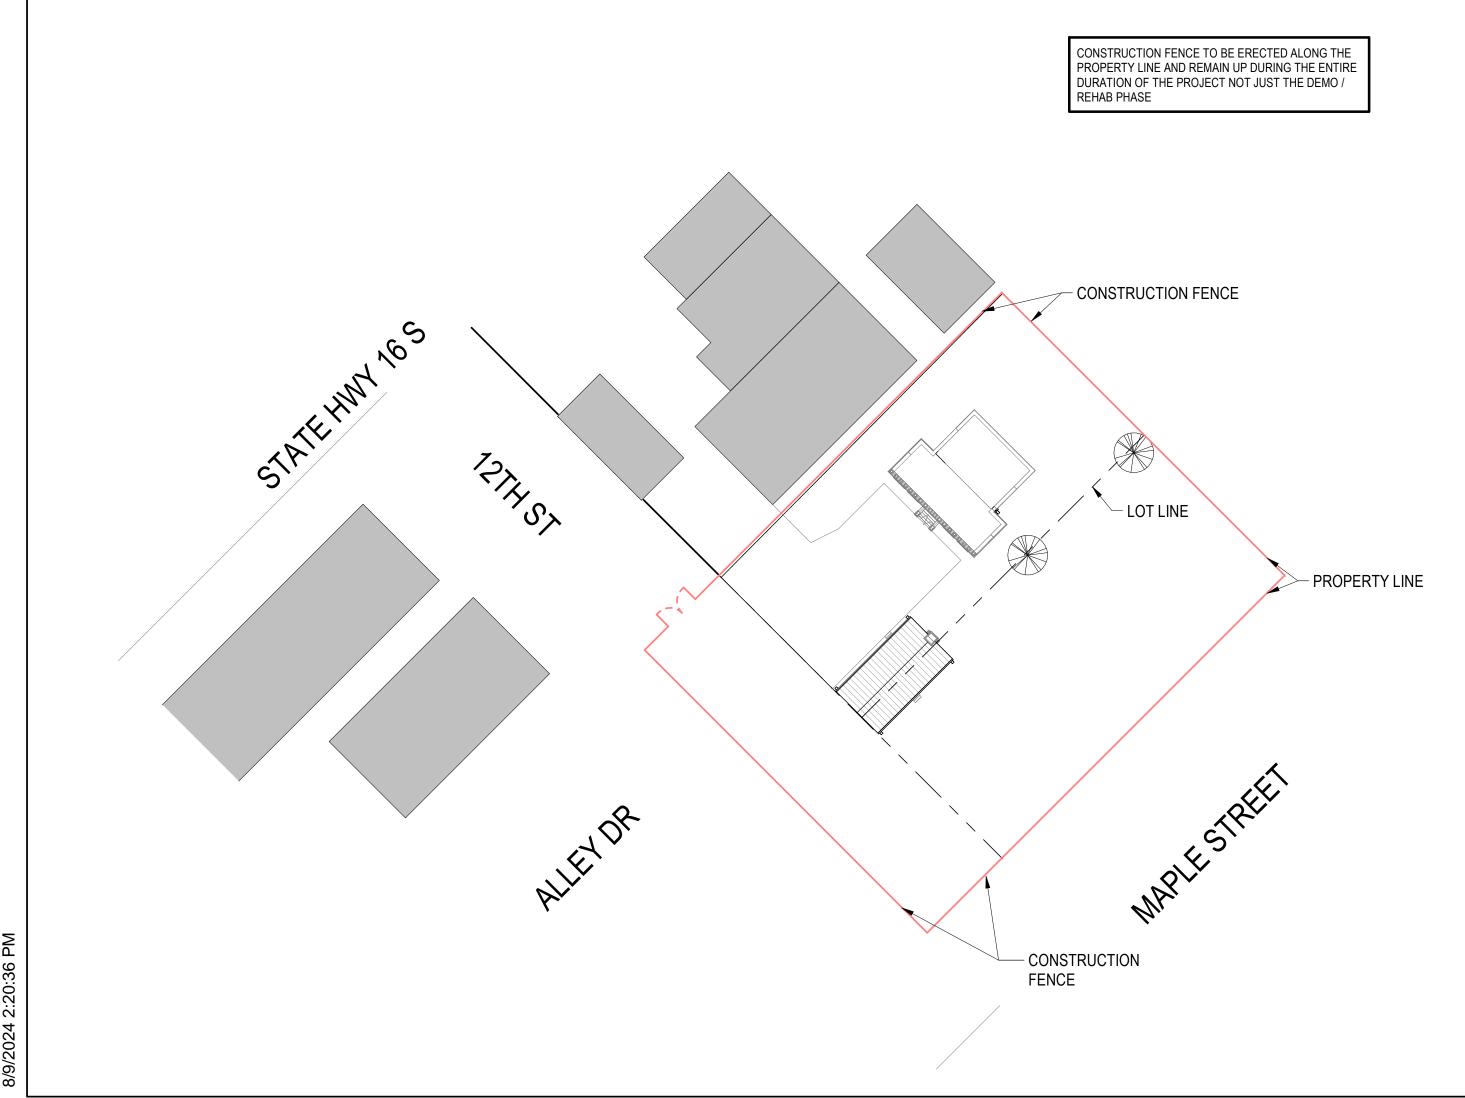
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LOCATION MAPS



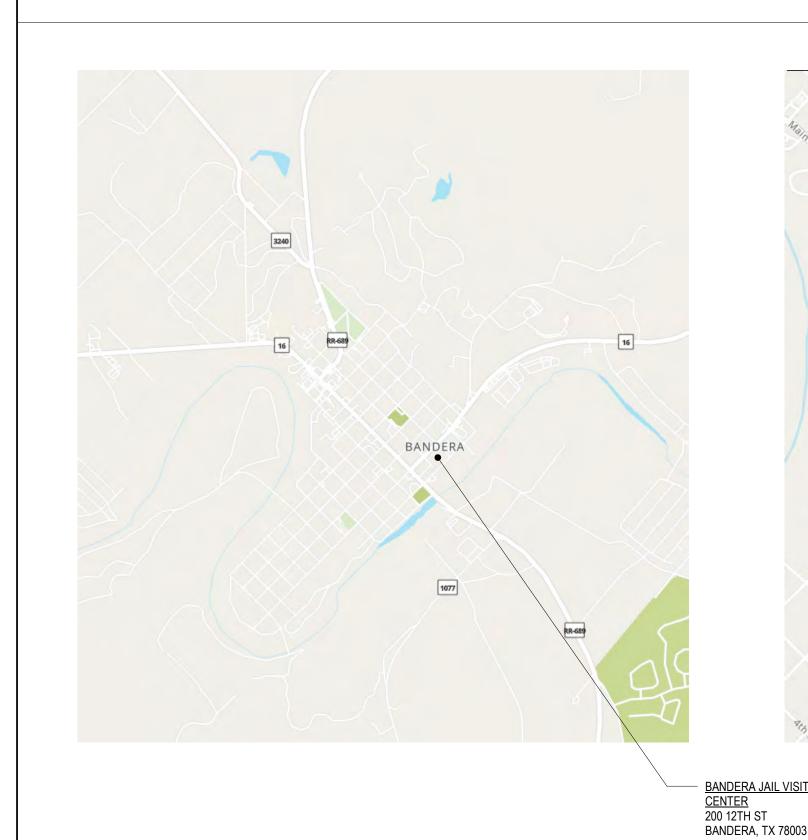

CONSTRUCTION SITE PLAN

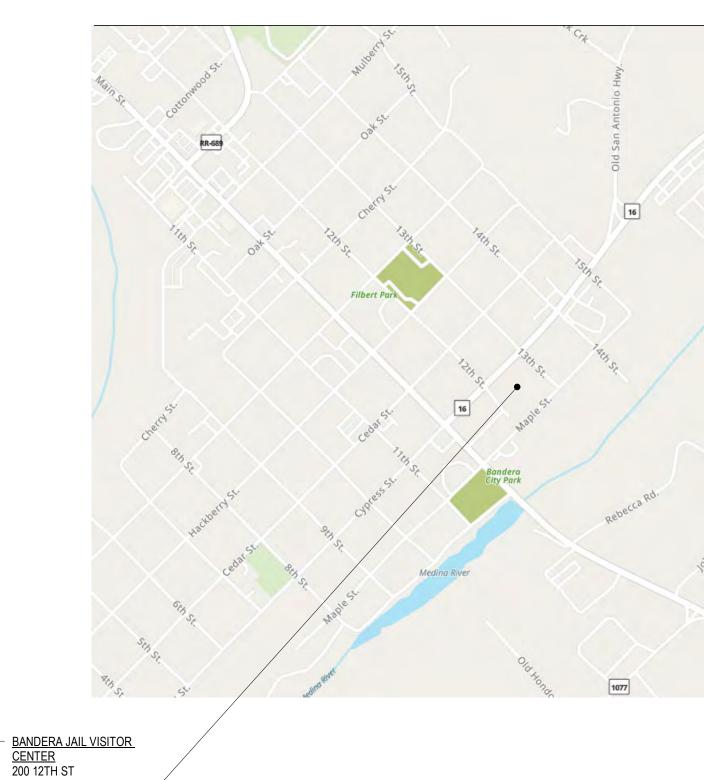

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GENERAL

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DEMOLITION


DEMOLITION PLANS - 1877 COURTHOUSE **DEMOLITION PLANS - 1881 JAIL**

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ABBREVIATIONS



GENERAL NOTES

1.	THESE DOCUMENTS SHOULD NOT BE CONSIDERED AS A SURVEY OF EXISTING CONDITIONS. THE GENERAL CONTRACTOR SHALL FIELD VERIFY ALL EXISTING DIMENSIONS AND CONDITIONS, AND NOTIFY THE ARCHITECT OF ANY DISCREPANCIES OR OMISSIONS BETWEEN THE CONTRACT DOCUMENTS AND FIELD CONDITIONS
	BEFORE COMMENCING ANY WORK AND REQUEST CLARIFICATION.
2.	ALL NOTES REFERENCE NEW WORK UNLESS NOTED AS EXISTING.

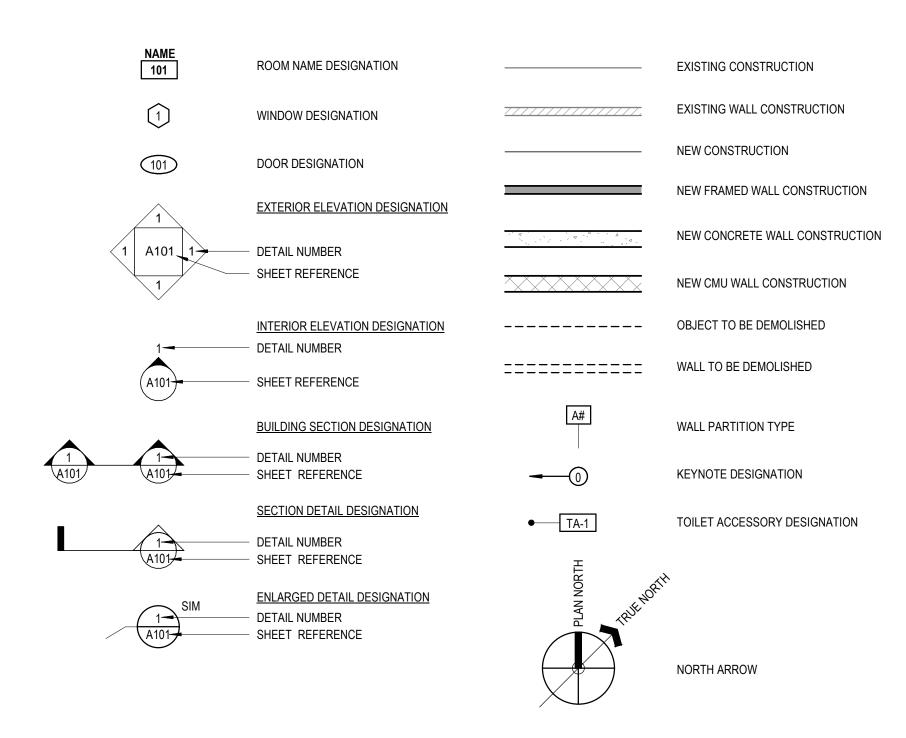PATCH ALL SURFACES AND AREAS AFFECTED BY DEMOLITION AND PREPARE FOR REHABILITATION.

REMOVE ALL DEBRIS, RUBBISH AND OTHER MATERIALS RESULTING FROM DEMOLITION.

THE EXTENT OF DEMOLITION WORK IS SHOWN ON THE DRAWINGS. IT IS NOT POSSIBLE TO SHOW REQUIRED DEMOLITION, REMODELING AND PATCHING IN EVERY DETAIL. THE CONTRACTOR SHALL VISIT THE FACILITY TO DETERMINE THE EXTENT OF DEMOLITION AND REMODELING WORK, AND TO FAMILIARIZE HIMSELF WITH THE CONDITIONS UNDER WHICH THE WORK WILL BE PERFORMED. NO ADDITIONAL COMPENSATION WILL BE ALLOWED FOR ADDITIONAL WORK REQUIRED AS A RESULT OF THE WORK INDICATED HEREIN OR FOR PATCHING REQUIRED AS A RESULT OF NEW WORK, REMODELING OR DEMOLITION.

IT IS NOT POSSIBLE FOR THE ARCHITECT TO NOTE ALL DETERIORATED CONDITIONS. THE CONTRACTOR SHALL VISIT THE FACILITY TO DETERMINE THE CONDITION

UNLESS SPECIFICALLY DESIGNATED FOR SALVAGE, DEMOLITION INCLUDES REMOVAL AND DISPOSAL OF DEMOLISHED MATERIALS. CONTRACTOR SHALL PROVIDE ITEMS INDICATED FOR SALVAGE BY OWNER SHALL BE REMOVED BY THE CONTRACTOR AND DELIVERED TO OWNER'S DESIGNATED STORAGE AREA.

10. REPAIR, AT NO COST TO THE OWNER, DAMAGE CAUSED TO ADJACENT AREAS, MATERIALS AND EQUIPMENT BY DEMOLITION AND NEW CONSTRUCTION OPERATIONS.

12. THE CONTRACTOR IS RESPONSIBLE FOR DETERMINING SHORING REQUIREMENTS IF NECESSARY 13. THE GENERAL AND SUBCONTRACTOR(S) MUST COMPLY WITH ALL RULES AND REGULATIONS OF AGENCIES HAVING JURISDICTION AND SHALL CONFORM TO ALL CITY, STATE, AND FEDERAL CONSTRUCTION SAFETY AND SANITARY LAWS, CODES, STATUTES, AND ORDINANCES.

CODE INFO & ANALYSIS APPLICABLE CODES AND STANDARDS:

APPLICABLE CODES AND STANDARDS:

THIS PROJECT IS IN THE CITY OF BANDERA, TEXAS. THE CITY OF BANDERA CURRENTLY HAS ADOPTED THE FOLLOWING CODES WITH LOCAL AMENDMENTS:

• 2018 INTERNATIONAL FIRE CODE • 2018 INTERNATIONAL MECHANICAL CODE

1877 COURTHOUSE:

OCCUPANCY CLASSIFICATION: • ALTERATION - LEVEL 3

AREAS:ACTUAL TOTAL AREA (EXISTING)

• 2018 NATIONAL ELECTRICAL CODE • 2018 INTERNATIONAL ENERGY CONSERVATION CODE

OCCUPANCY CLASSIFICATION: • ALTERATION - LEVEL 3

• ACTUAL TOTAL AREA (EXISTING) - 2.230 SF

CAMBOLC

	SYM	BOL	.S
)	AND AT POUND, NUMBER CENTER LINE	MAS MAX MDP MECH MED	MASONRY MAXIMUM MAIN DISTRIBUTION PANEL MECHANICAL MEDIUM
CT DDN. DDN'L DJ FF HU	ACOUSTICAL CEILING ADDITION ADDITIONAL ADJUSTABLE ABOVE FINISHED FLOORS AIR HANDLING UNIT	MFR MH MN MISC MO MTD	MANUFACTURER MANHOLE MINIMUM MISCELLANEOUS MASONRY OPENING MOUNTED
LT LUM PPROX RCH	ALTERNATE ALUMINUM APPROXIMATE ARCHITECT, ARCHITECTURE	MTL N NIC NO	METAL NORTH NOT IN CONTRACT NUMBER
O. CS D LDG	BOTTOM OF BABY CHANGING STATION BOARD BUILDING	NOM NTS OC OD	NOMINAL NOT TO SCALE ON CENTER OUTSIDE DIAMETER
FM FT J FA LLG	CUBIC FEET PER MINUTE CERAMIC FLOOR TILE CONTROL JOINT CLEAR FLOOR AREA CEILING	O.H. OPP OZ P	OPPOSITE HAND OPPOSITE OUNCE PAINT
LR MU O OL ONC	CLEAR CONCRETE MASONRY UNIT CLEAN OUT COLUMN CONCRETE	PCF PERF PL PLAM PLUM	POUNDS PER CUBIC FOOT PERFORATED PLATE PLASTIC LAMINATE PLUMBING
ONST CONT PT PTB TB WT	CONSTRUCTION-CONTINUOUS CARPET CARPET BASE CERAMIC TILE BASE CERAMIC WALL TILE	PLF PLYWD PR PSF PSI	POUNDS PER LINEAR FOOT PLYWOOD PAIR POUNDS PER SQUARE FOOT POUNDS PER SQUARE INCH
W I U UH W	CONDENSING UNIT CABINET UNIT HEATER COLD WATER DETAIL	PT PTD PVC PVMT	POINTS PER SQUARE INCH POINT PAINTED POLYVINYL CHLORIDE PAVEMENT
IA IM ISP N	DIAMETER DIMENSION DISPENSER DOWN	QT QTY R	QUARRY TILE QUANTITY RISER, RADIUS
S W WG	DOWNSPOUT DUMB WAITER DRAWING EAST	RB RCP RD RE: REF	RUBBÉR BASE BOARD REFLECTED CEILING PLAN ROOF DRAIN REFER TO REFRIGERATOR
A J LEV LEC P	EACH EXPANSION JOINT ELEVATION ELECTRICAL ELECTRICAL PANEL	REINF REQ REV RF RH	REINFORCE (D) REQUIRED REVISIONS RESILIENT FLOORING RIGHT HAND
Q QUIP WC WH XH	EQUAL EQUIPMENT ELECTRIC WATER COOLER ELECTRIC WATER HEATER EXHAUST	RM RO ROW RS RTU	ROOM ROUGH OPENING RIGHT OF WAY ROUGH SAWN ROOF TOP UNIT
XP XT A ACP	EXPANSION EXTERIOR FIRE ALARM FIRE ALARM CONTROL PANEL	S SAN SAT SC	SOUTH SANITARY SUSPENDED ACOUSTICAL TILE SOLID CORE / OVERFLOW SCUPPER
) = =C =	FLOOR DRAIN, FIRE DAMPER FIRE EXTINGUISHER FIRE EXTINGUISHER CABINET FINISHED FLOOR FINISHED GRADE	SCHED SECT SERV SF SIM	SCHEDULE SECTION SERVICE SQUARE FEET SIMILAR
N _R('G) D F FG	FINISH(ED) FLOOR(ING) FACE OF FOOT, FEET FOOTING	SPEC SQ SS ST STD	SPECIFICATIONS SQUARE STAINLESS STEEL STORM STANDARD
JRN NC A	FURNISH(ED) FABRIC WALL COVERING GAUGE GALVANIZED	STL STRUCT SUSP SWG SYM	STANDARD STEEL STRUCTURAL SUSPENDED STANDARD WIRE GAUGE SYMMETRICAL
C FI L YP	GENERAL CONTRACTOR GROUND FAULT INTERRUPTER GLASS GYPSUM	T T&B T&G TEL	TREAD TOP AND BOTTOM TONGUE AND GROOVE TELEPHONE
B C WD ID	HOSE BIBB HOLLOW CORE HARDWOOD HIGH INTENSITY DISCHARGE	TEMP THK T.O. TYP	TEMPERATURE, TEMPERED THICK (NESS) TOP OF TYPICAL
M ORIZ VAC W	HOLLOW METAL HORIZONTAL HEAT, VENT, A/C HOT WATER	TV UG UH UNO	TELEVISION UNDERGROUND UNIT HEATER UNLESS NOTED OTHERWISE
ICL IT IV	INSIDE DIAMETER INCLUDING INTERIOR INVERT	VB VCT VERT VIF	VINYL BASE BOARD VINYL COMPOSITION TILE VERTICAL VERIFY IN FIELD
B ST	JUNCTION BOX JOIST KIP (1,000 POUNDS)	VIF VWC W W/	VERIFY IN FIELD VINYL WALL COVERING WEST WITH
AM AV 3	LAMINATED LAVATORY POUND	W/O WB WC WD	WITHOUT WOOD BASE BOARD WATER CLOSET WOOD
= - _H	LINEAR FEET LEFT HAND LIVE LOAD LONG LEG HORIZONTAL	WH WP WT WWF	WATER HEATER WATERPROOF, WORK POINT WEIGHT WELDED WIRE FABRIC
_V	LONG LEG VERTICAL LIGHTNING PANEL	YD	YARD

Fisher

INFORMATION

PROJECT

GENERAL

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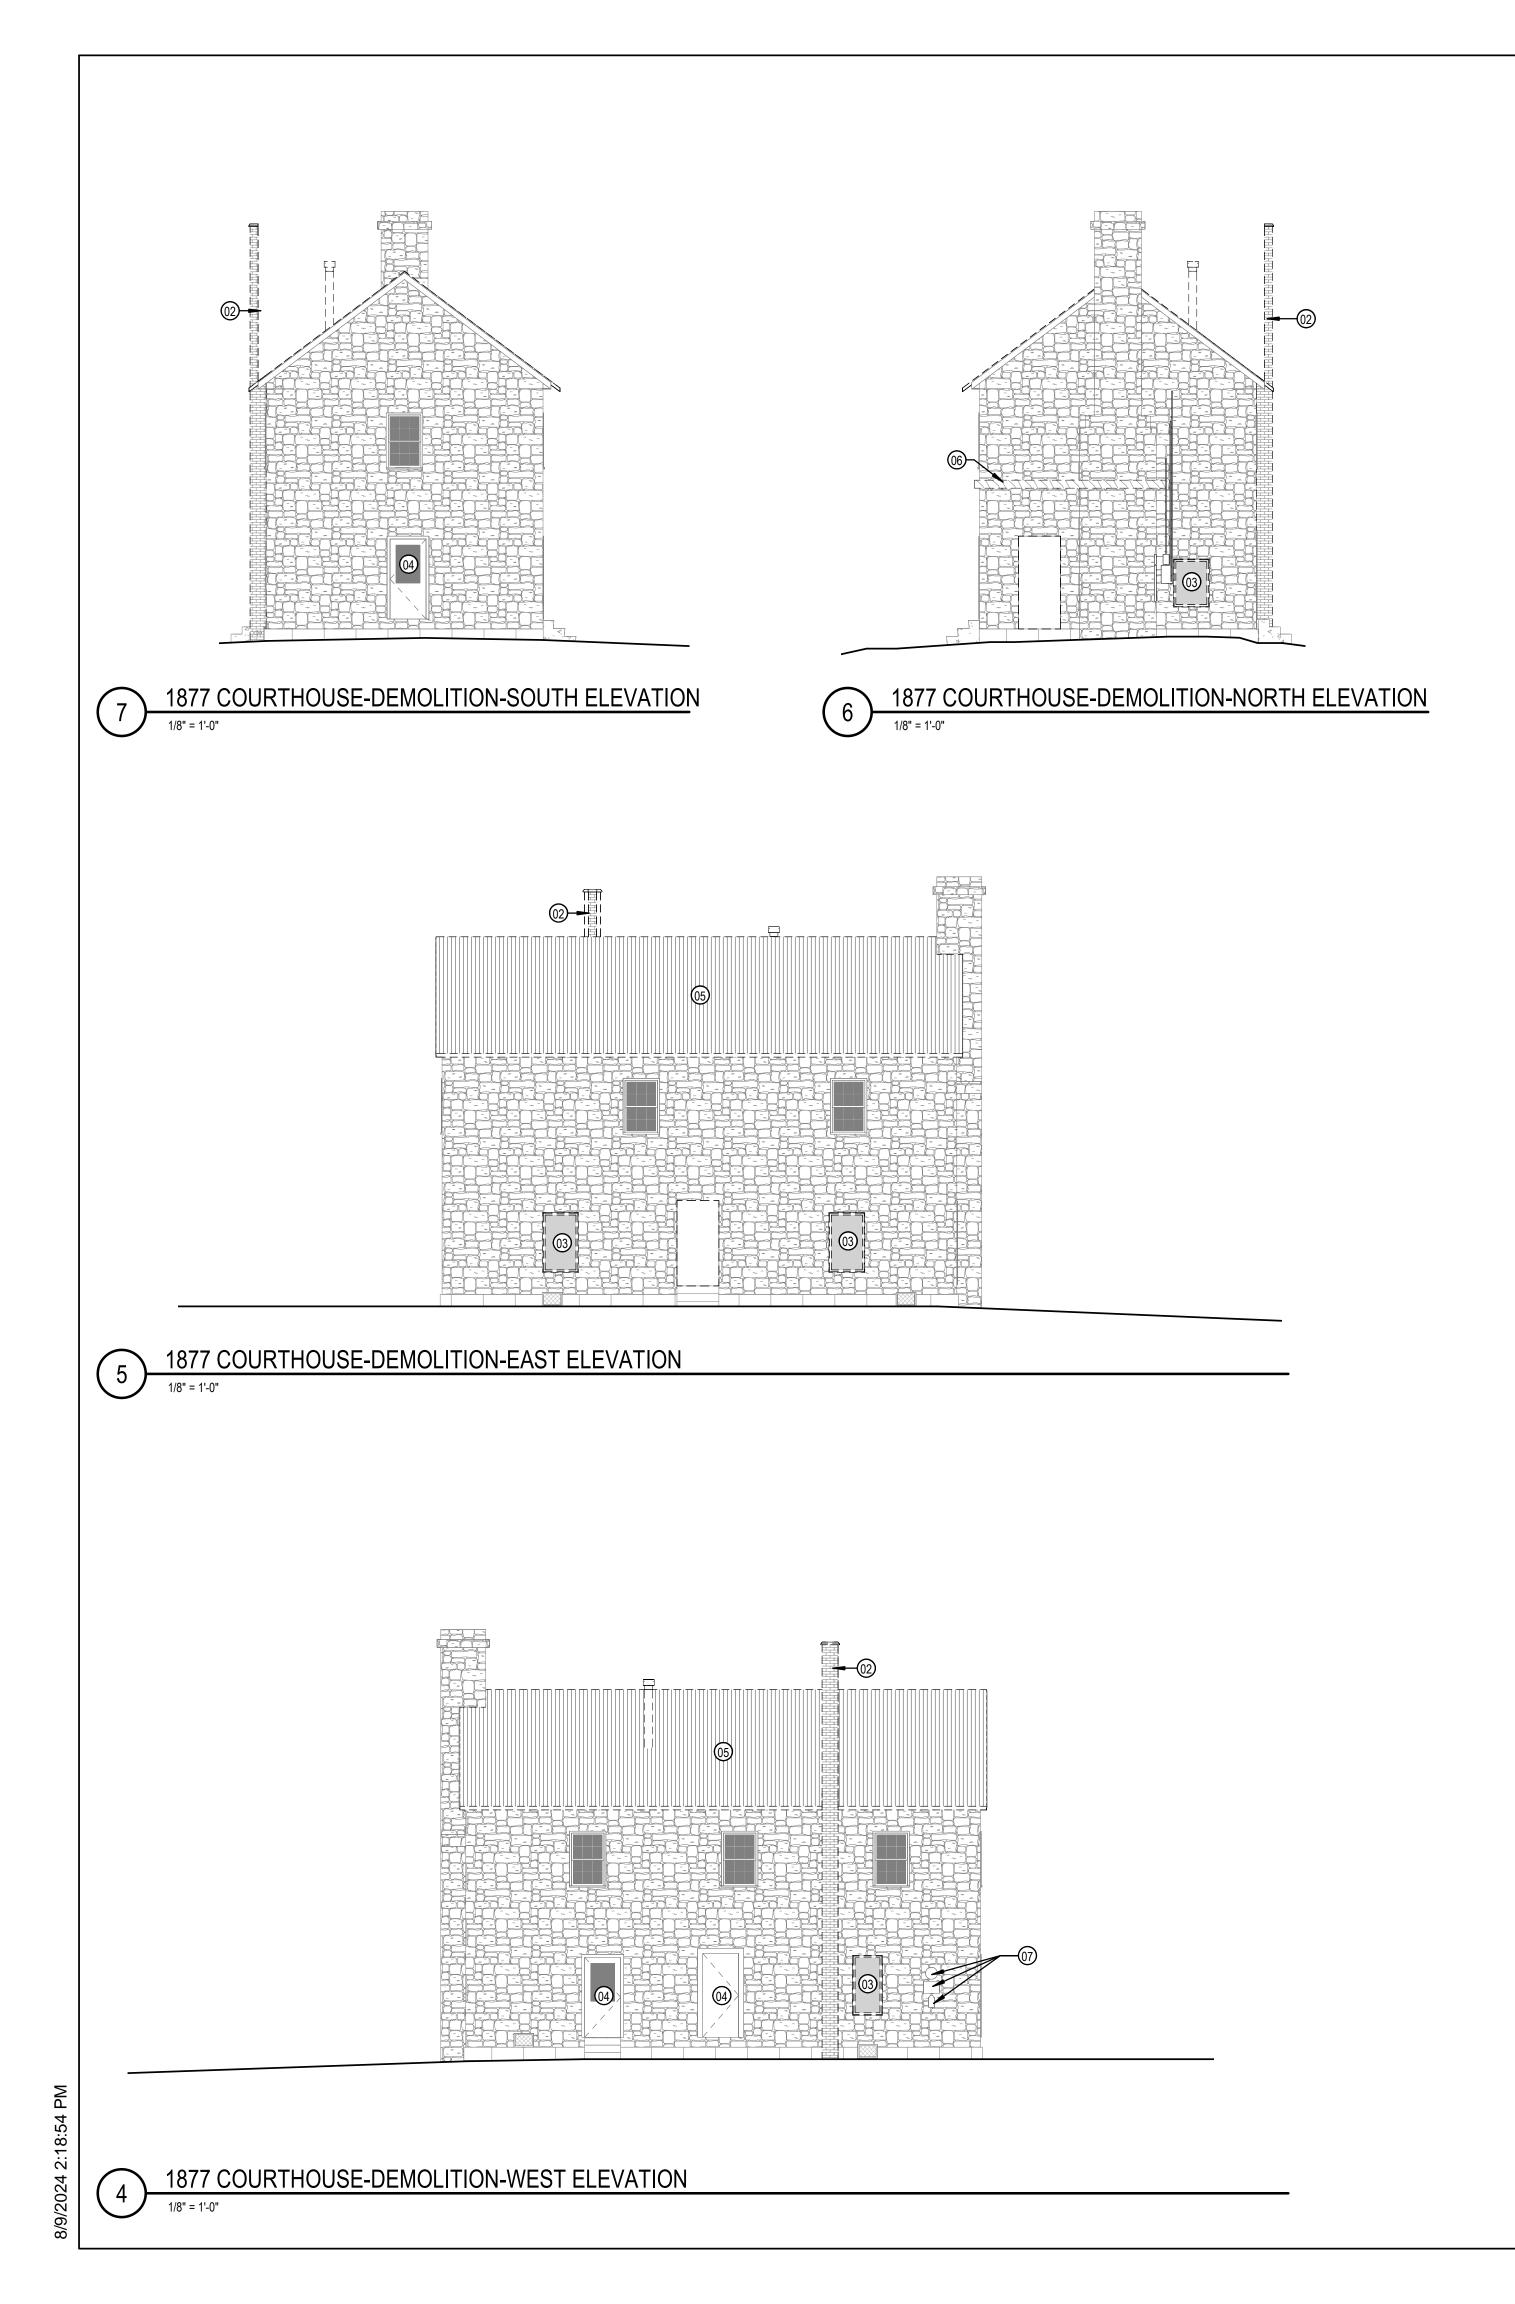
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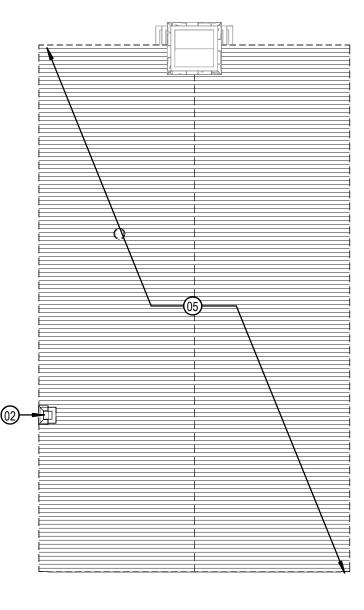
COUNTY VISITOR

BANDERA


PROJECT NO: 2301 A1

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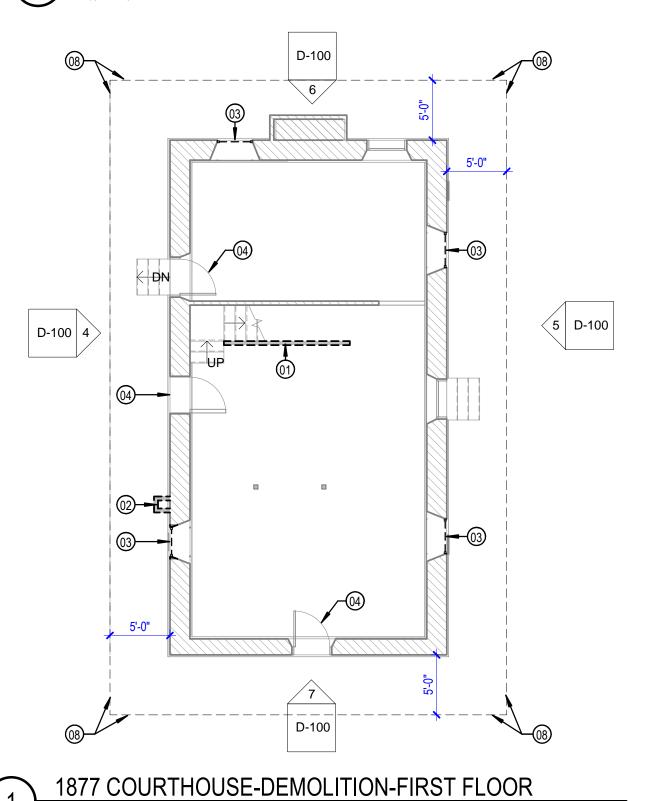




1877 COURTHOUSE-DEMOLITION-ROOF

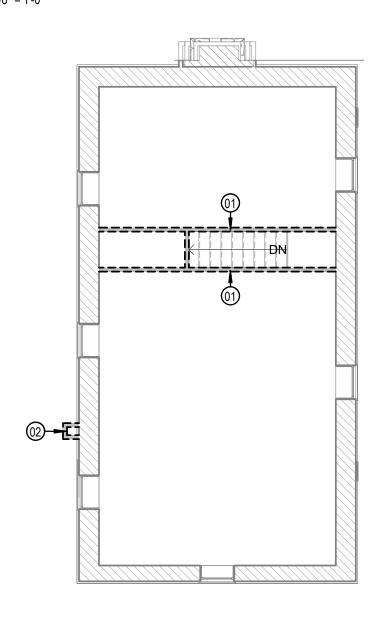

1877 COURTHOUSE-DEMOLITION-SECOND FLOOR



GENERAL NOTES

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- 2. THESE DOCUMENTS SHOULD NO BE CONSIDERED AS A SURVEY OF EXISTING CONDITIONS. THE GENERAL CONTRACTOR SHALL NOTIFY ARCHITECT IMMEDIATELY OF ANY DISCREPANCIES OR
- OMISSIONS BETWEEN DOCUMENTS AND FIELD CONDITIONS BEFORE COMMENCING ANY WORK AND REQUEST CLARIFICATION. 3. ELEMENTS NOTED WITHIN KEYNOTES ARE BASED UPON VISUAL OBSERVATIONS AT THE TIME OF SURVEY, CONTRACTOR TO
- VERIFY ANY ADDITIONAL DETERIORATION. 4. FIELD VERIFY ALL EXISTING DIMENSIONS, ELEVATIONS, & CONDITIONS PRIOR TO COMMENCEMENT OF WORK.
- 5. ALL DIMENSIONS ARE TO FACE OF MATERIAL UNLESS NOTED
- 6. ALL DOOR AND WINDOWS THAT ARE TO REMAIN SHALL BE PROTECTED DURING CONSTRUCTION. 7. DO NOT REMOVE BASE BOARDS OR OTHER WOODEN TRIM;
- EXCEPT DURING REPOINTING AND REPLASTERING WHERE NEEDED, PROTECT DURING CONSTRUCTION.

KEYNOTES

- 01 DEMO WOOD STUD WALL AFTER REHABILITATION WORK HAS BEEN COMPLETED; PREP AREA TO RECEIVE TEMPORARY STAIR RAIL
- 02 CAREFULLY DECONSTRUCT NON-ORIGINAL BRICK MASONRY CHIMNEY. VOID WITHIN WALL THAT RESULTS FROM THE REMOVAL OF THE CHIMNEY, SHALL BE FILLED WITH MATCHING STONE WITH A LIME-BASED MORTAR
- 03 DEMO NON-HISTORIC METAL FRAMED WINDOW. PREP OPEINIG TO RECIEVE REPLICA WOOD WINDOW.
- 04 PROTECT DOOR DURING CONSTRUCTION
- 05 DEMO METAL ROOF, WOOD UNDERLAYMENT AND INSULATION; WOOD RAFTERS IN GOOD CONDITION MAY REMAIN, DETERIORATED RAFTERS MAY REQUIRE REPLACEMENT OR SISTERING. CONTRACTOR TO DETERMINE IN THE FIELD.
- 06 CAREFULLY DEMO REMAINING SHED ROOF AND PREP STONE WALL FOR REPAIR 07 CAREFULLY REMOVE HISTORIC PLAQUES AND MARK DOWN
- EXACT LOCATION FOR RE-PLACEMENT AFTER REHABILITATION WORK IS COMPLETED
- 08 REMOVE ALL VEGETATION WITHIN DESIGNATED AREA AROUND THE BUILDING ENSURE THAT IT WILL NOT REGROW

BANDERA COUNTY VISITOR CENTER SHEFTITLE:


DEMOLITION PLANS -


COURTHOUSE


1877

PROJECT NO: 2301 A1

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- OMISSIONS BETWEEN DOCUMENTS AND FIELD CONDITIONS BEFORE COMMENCING ANY WORK AND REQUEST CLARIFICATION. 3. ELEMENTS NOTED WITHIN KEYNOTES ARE BASED UPON VISUAL OBSERVATIONS AT THE TIME OF SURVEY, CONTRACTOR TO VERIFY ANY ADDITIONAL SUBSEQUENT DAMAGE THAT MAY HAVE
- 4. FIELD VERIFY ALL EXISTING DIMENSIONS, ELEVATIONS, & CONDITIONS PRIOR TO COMMENCEMENT OF WORK.
- 5. ALL DIMENSIONS ARE TO FACE OF MATERIAL UNLESS NOTED
- 6. ALL DOOR AND WINDOWS THAT ARE TO REMAIN SHALL BE PROTECTED DURING CONSTRUCTION.
- 7. DO NOT REMOVE BASE BOARDS OR OTHER WOODEN TRIM; EXCEPT DURING REPOINTING AND REPLASTERING WHERE
- 8. SELECT AREAS OF FLOORING AND FLOOR STRUCTURE MAY NEED TO BE REMOVED DURING REPOINTING AND STABILIZATION OF FOUNDATION WALLS. CONTRACTOR WILL DETERMINE THE EXTENT OF REMOVALS NECESSARY UNDER MEANS AND METHODS. ANY FLOOR STRUCTURE REMOVED WILL BE DONE WITH SENSITIVITY SO IT HAS THE POTENTIAL FOR REUSE. REMOVED MATERIALS WILL BE LABELED AND CAREFULLY STORED WITHIN THE BUILDING
- 9. REPOINT100% OF EXTERIOR AND INTERIOR STONE WALLS. CAREFULLY REMOVE EXISTING MORTAR A MINIMUM OF 2 INCHES FROM FACE OF STONE.
- 10. REPOINTING MORTAR TO CONSIST OF 4 PARTS BUFF COLORED RIVER SAND, 1 PART LIME, 1/4 PART PORTLAND CEMENT.
- 11. SOME PORTIONS OF WALL MAY NEED TO BE DISASEMBLED, SHORED, AND REASSEMBLED USING SAME OR LIKE STONE. ELEVATION SHEETS INDICATE SOME OF THESE AREAS.
- CONTRACTOR WILL DETERMINE IF ADDITIONAL ARE NEEDED. 12. PROVIDE A TEMPORARY POWER IN EACH BUILDING.
- 13. PROVIDE A BUCKETLESS PORTABLE COMMERCIAL GRADE DEHUMIDIFIER FOR EACH BUILDING.
- 14. ALL VISIBLE EXPOSED WOOD SURFACES MUST BE PAINTED TO MATCH EXISTING SURFACE COLOR; PROVIDE SAMPLES TO ARCHITECT FOR APPROVAL, REFER TO SPECS FOR MORE INFO.

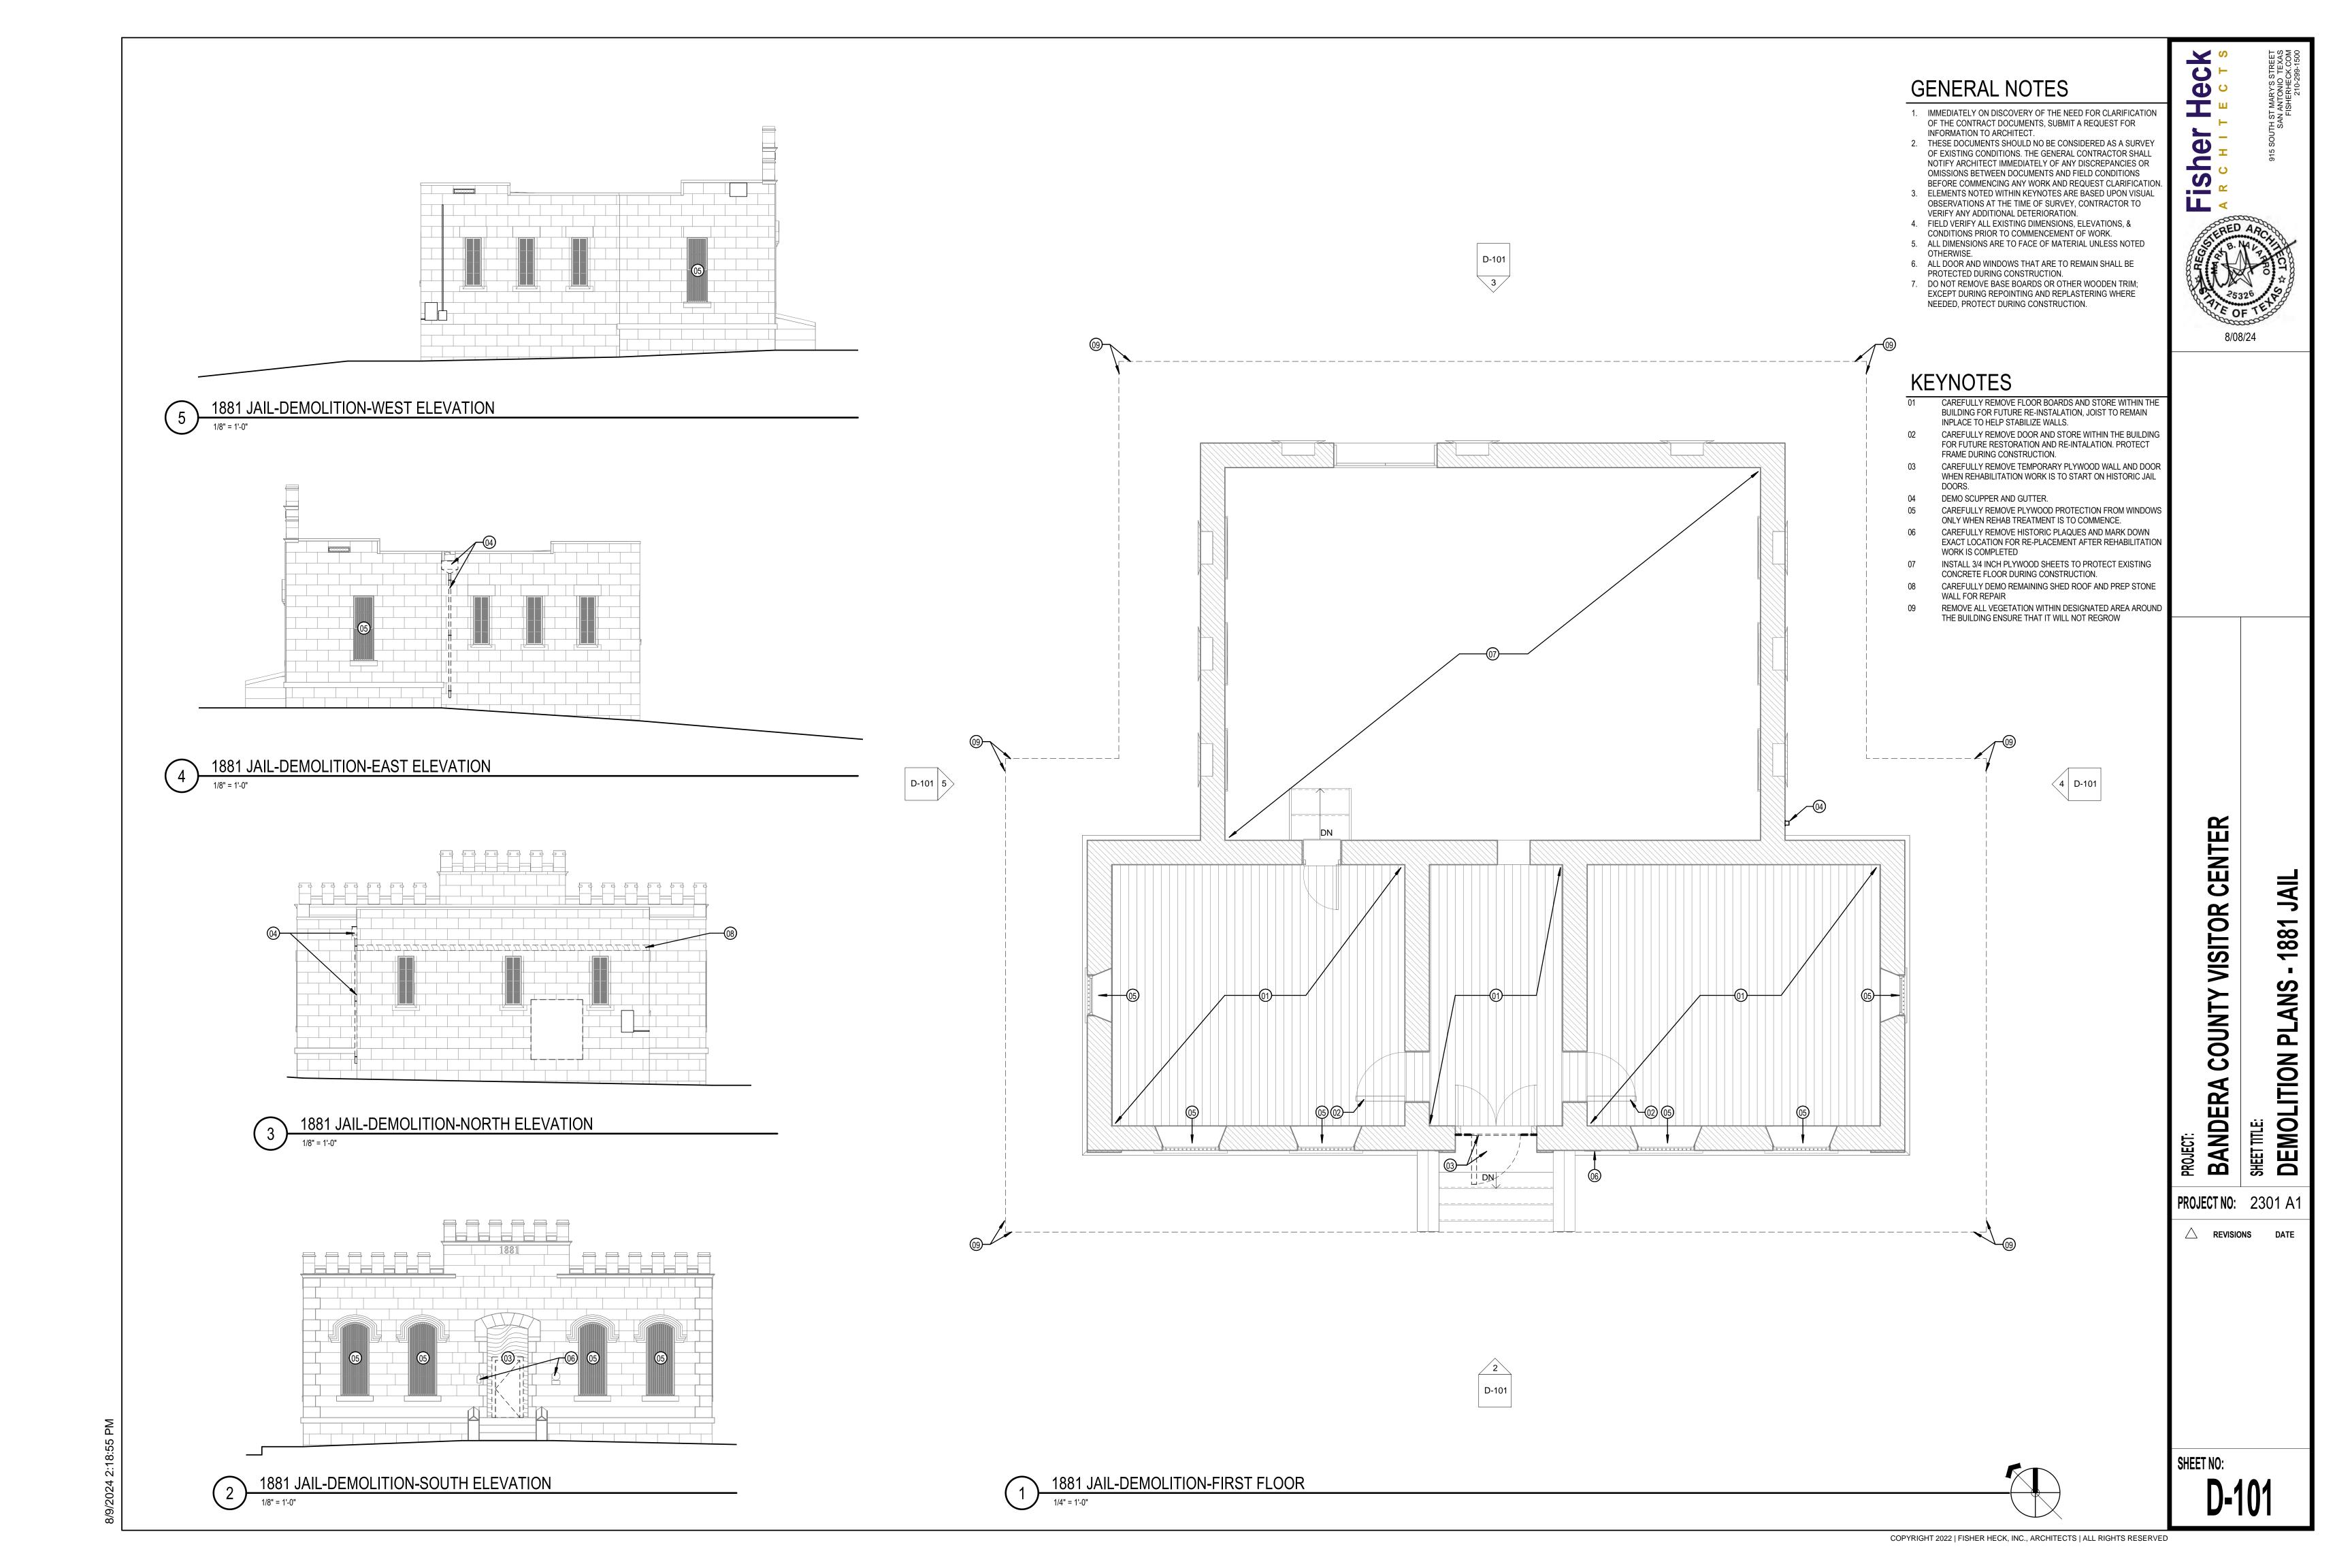KEYNOTES

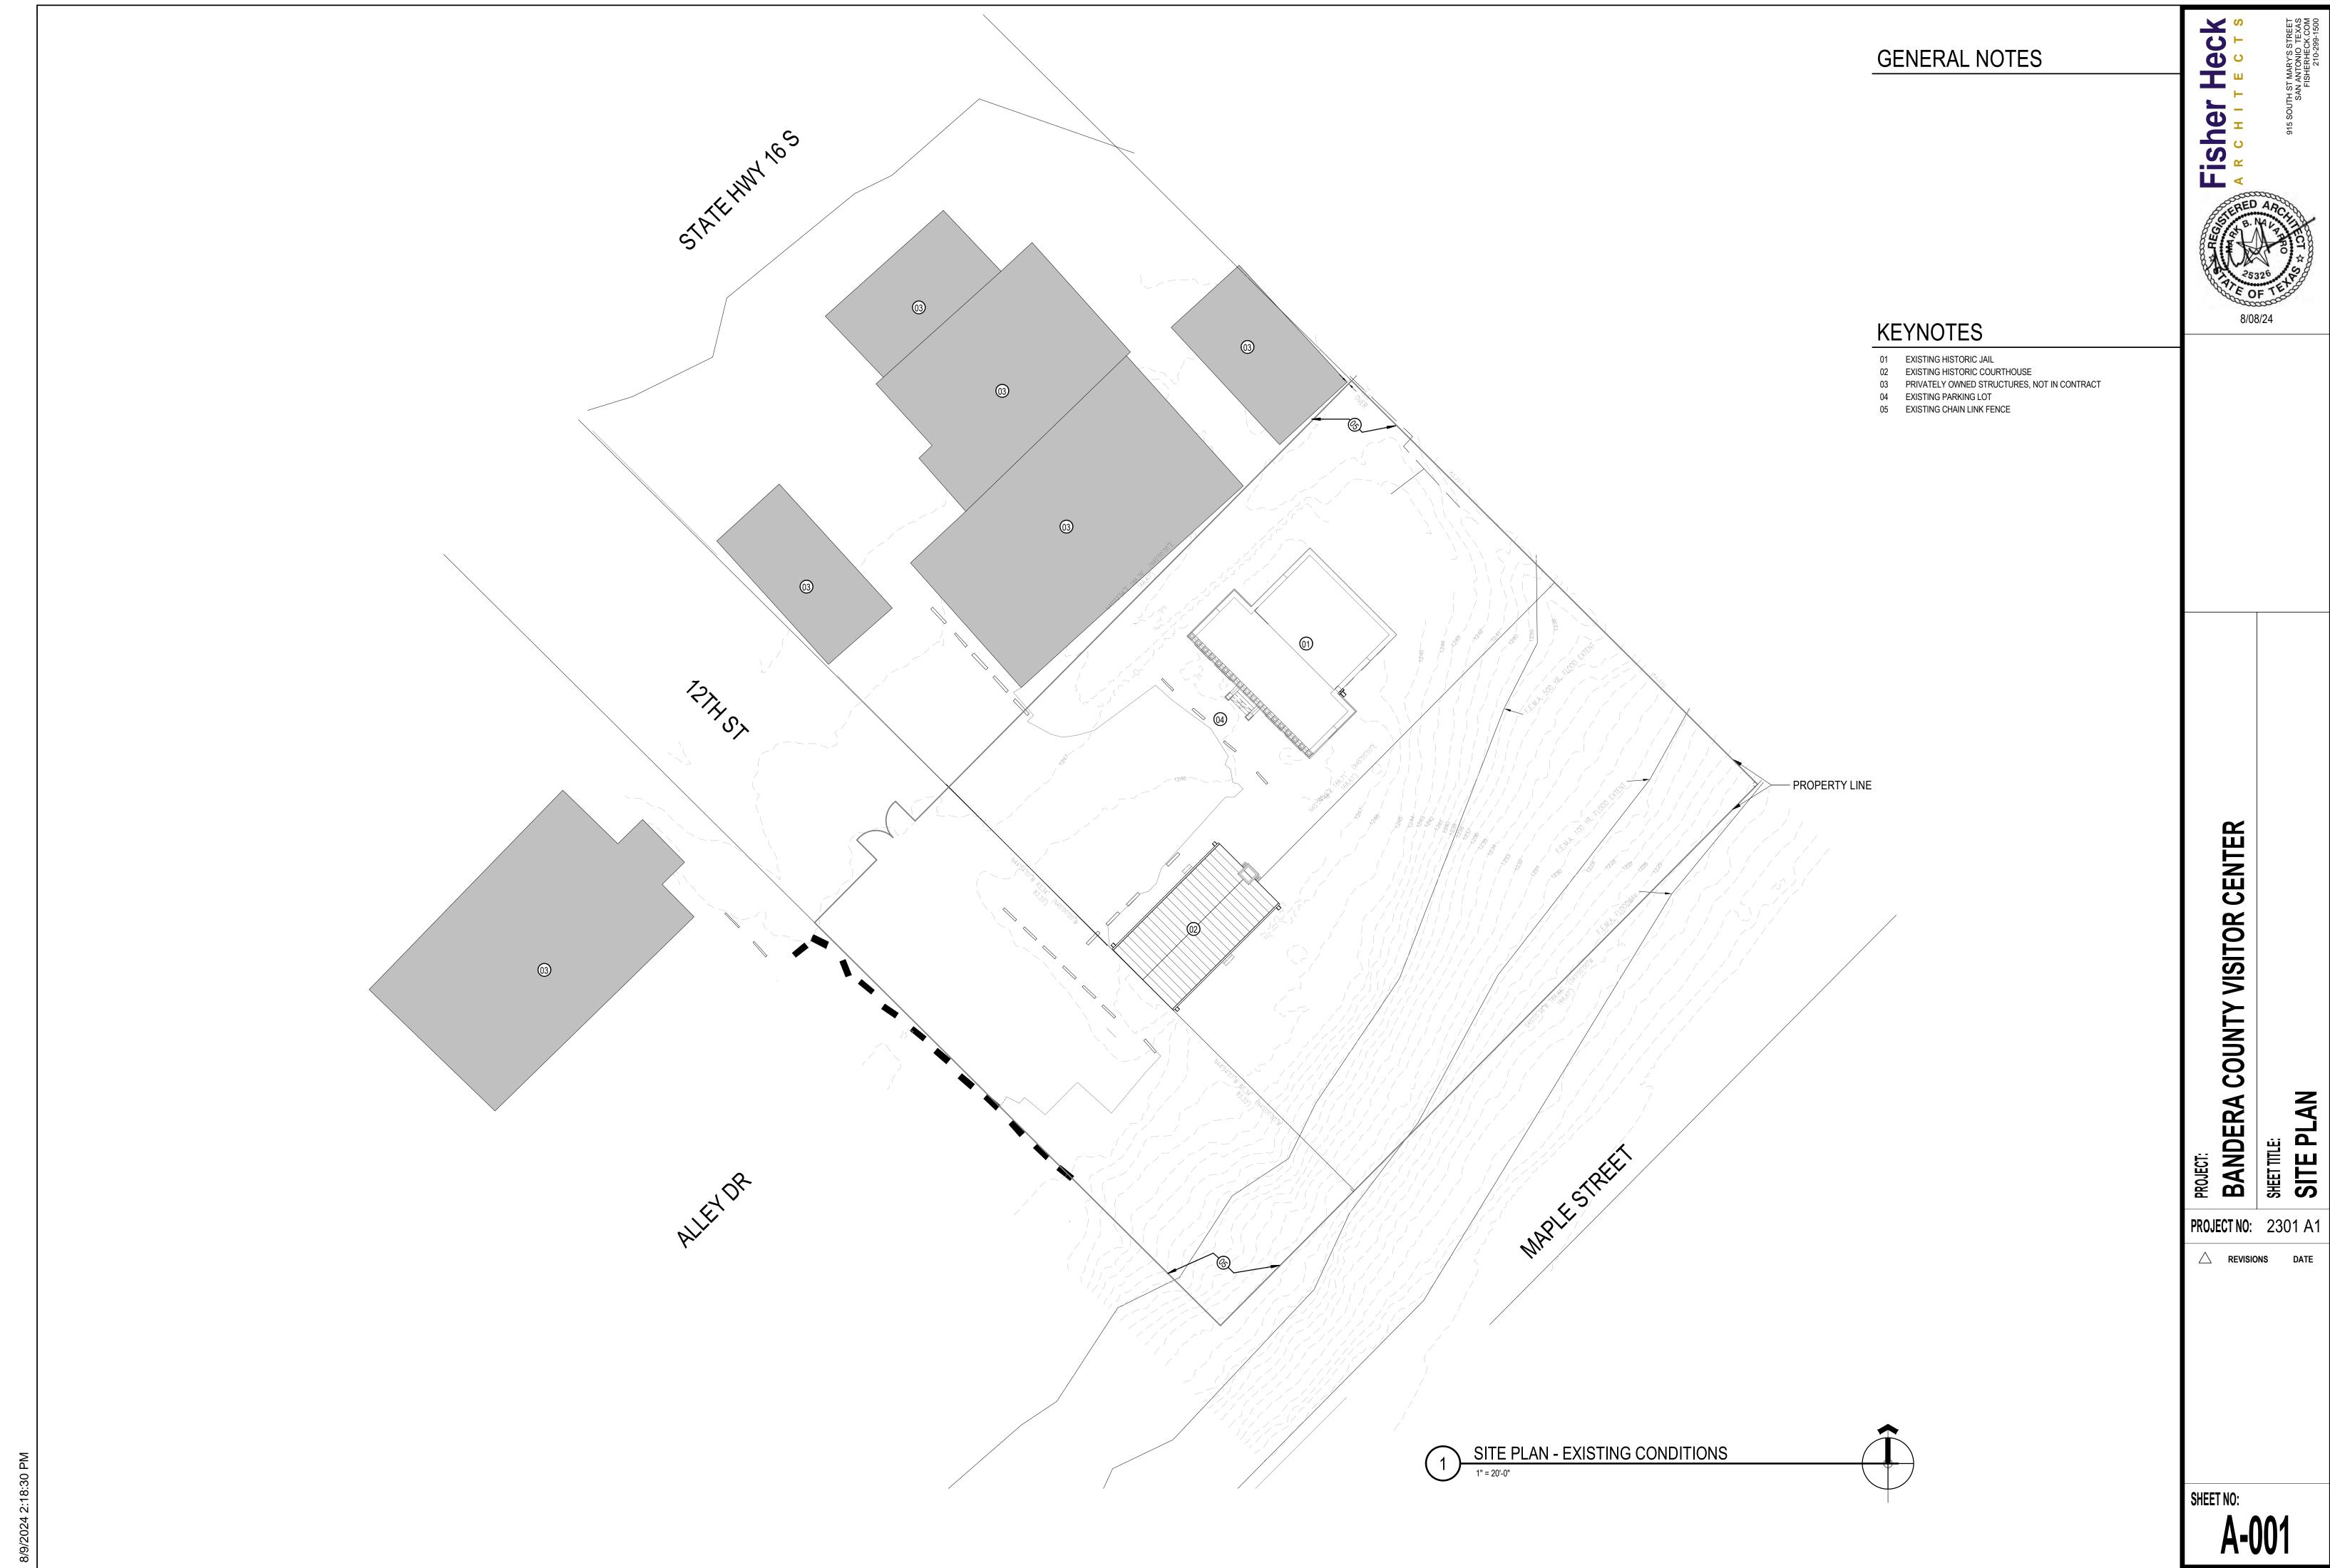- 01 REPAIR AND REPOINT BOTH SIDES OF EXISTING LIMESTONE FOUNDATION TO BOTTOM OF FOUNDATION OR 3'-0" MAX. BELOW GRADE. REPONTING SHOULD BE DONE IN NO MORE OF 5'-0" SECTIONS AT A TIME.
- CAREFULLY REMOVE ALL WOOD FRAMING; SALVAGE ALL ORIGINAL WOOD THAT REMAINS IN GOOD CONDITION AND STORE
- 03 REMOVE DEBRIS FROM CRAWL SPACE. REMOVE SOIL TO EXPOSE SIDES OF LIMESTONE FOOTINGS, AND REPOINT FACES OF
- 04 EXISTING STONE FOOTING; REPAIR AND REPOINT TO BOTTOM OF
- FOUNDATION OF 4'-0" MAX. 05 REPAIR AND REFINISH METAL GRILLE; REPLACE IN-KIND WHERE
- 06 GALVALUME 6" DOWNSPOUT TO MATCH GUTTER
- 07 TYP. PRECAST CONCRETE SPLASH BLOCK 24"Lx10"Wx3"H AT BASE OF DOWNSPOUT
- 08 REPOINT WALL; REFER TO GENERAL NOTES 9,10,11
- 09 BUILD TEMPORARY RAIL UP TO SECOND FLOOR
- PATCH / REPAIR CONCRETE STAIR AS NEEDED
- REPOINT STONE CHIMNEY'S FIRE BOX AND HEARTH; REFER TO GENERAL NOTES 9,10,11

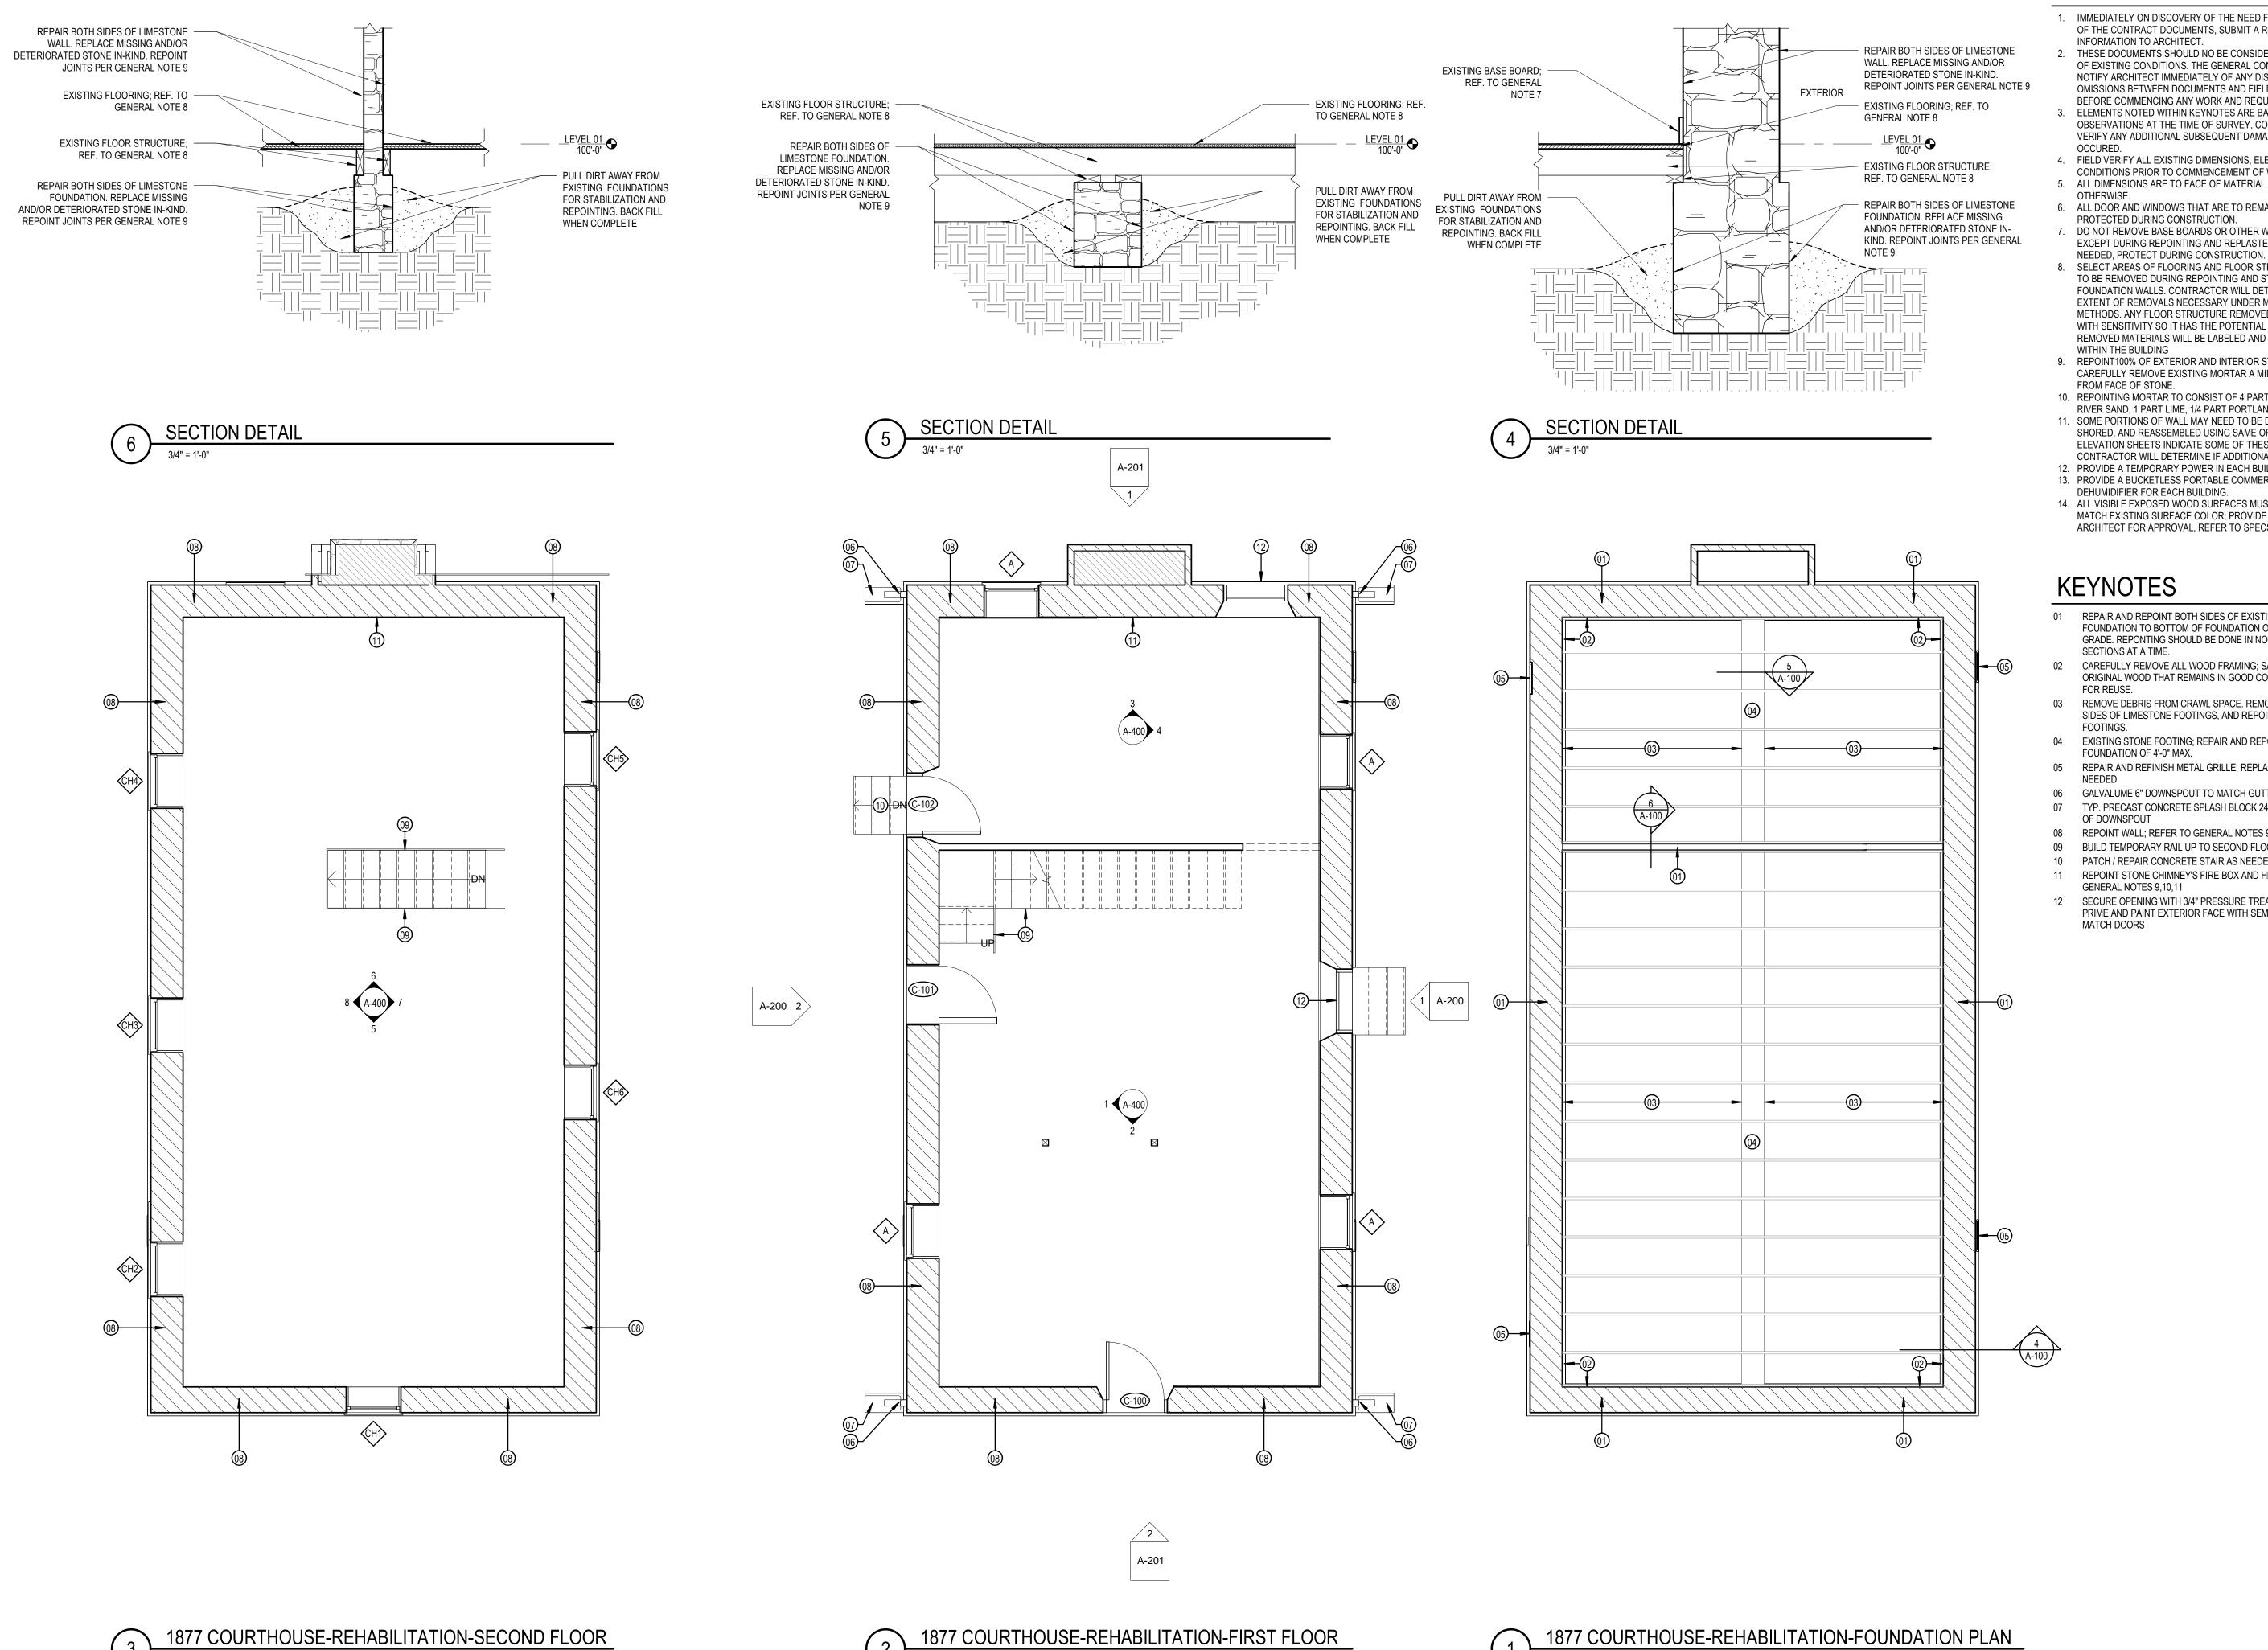SECURE OPENING WITH 3/4" PRESSURE TREATED PLYWOOD PRIME AND PAINT EXTERIOR FACE WITH SEMI GLOSS PAINT TO MATCH DOORS

COURTHOUSE

1877

SHEET TITLE:
REHABILITATION I


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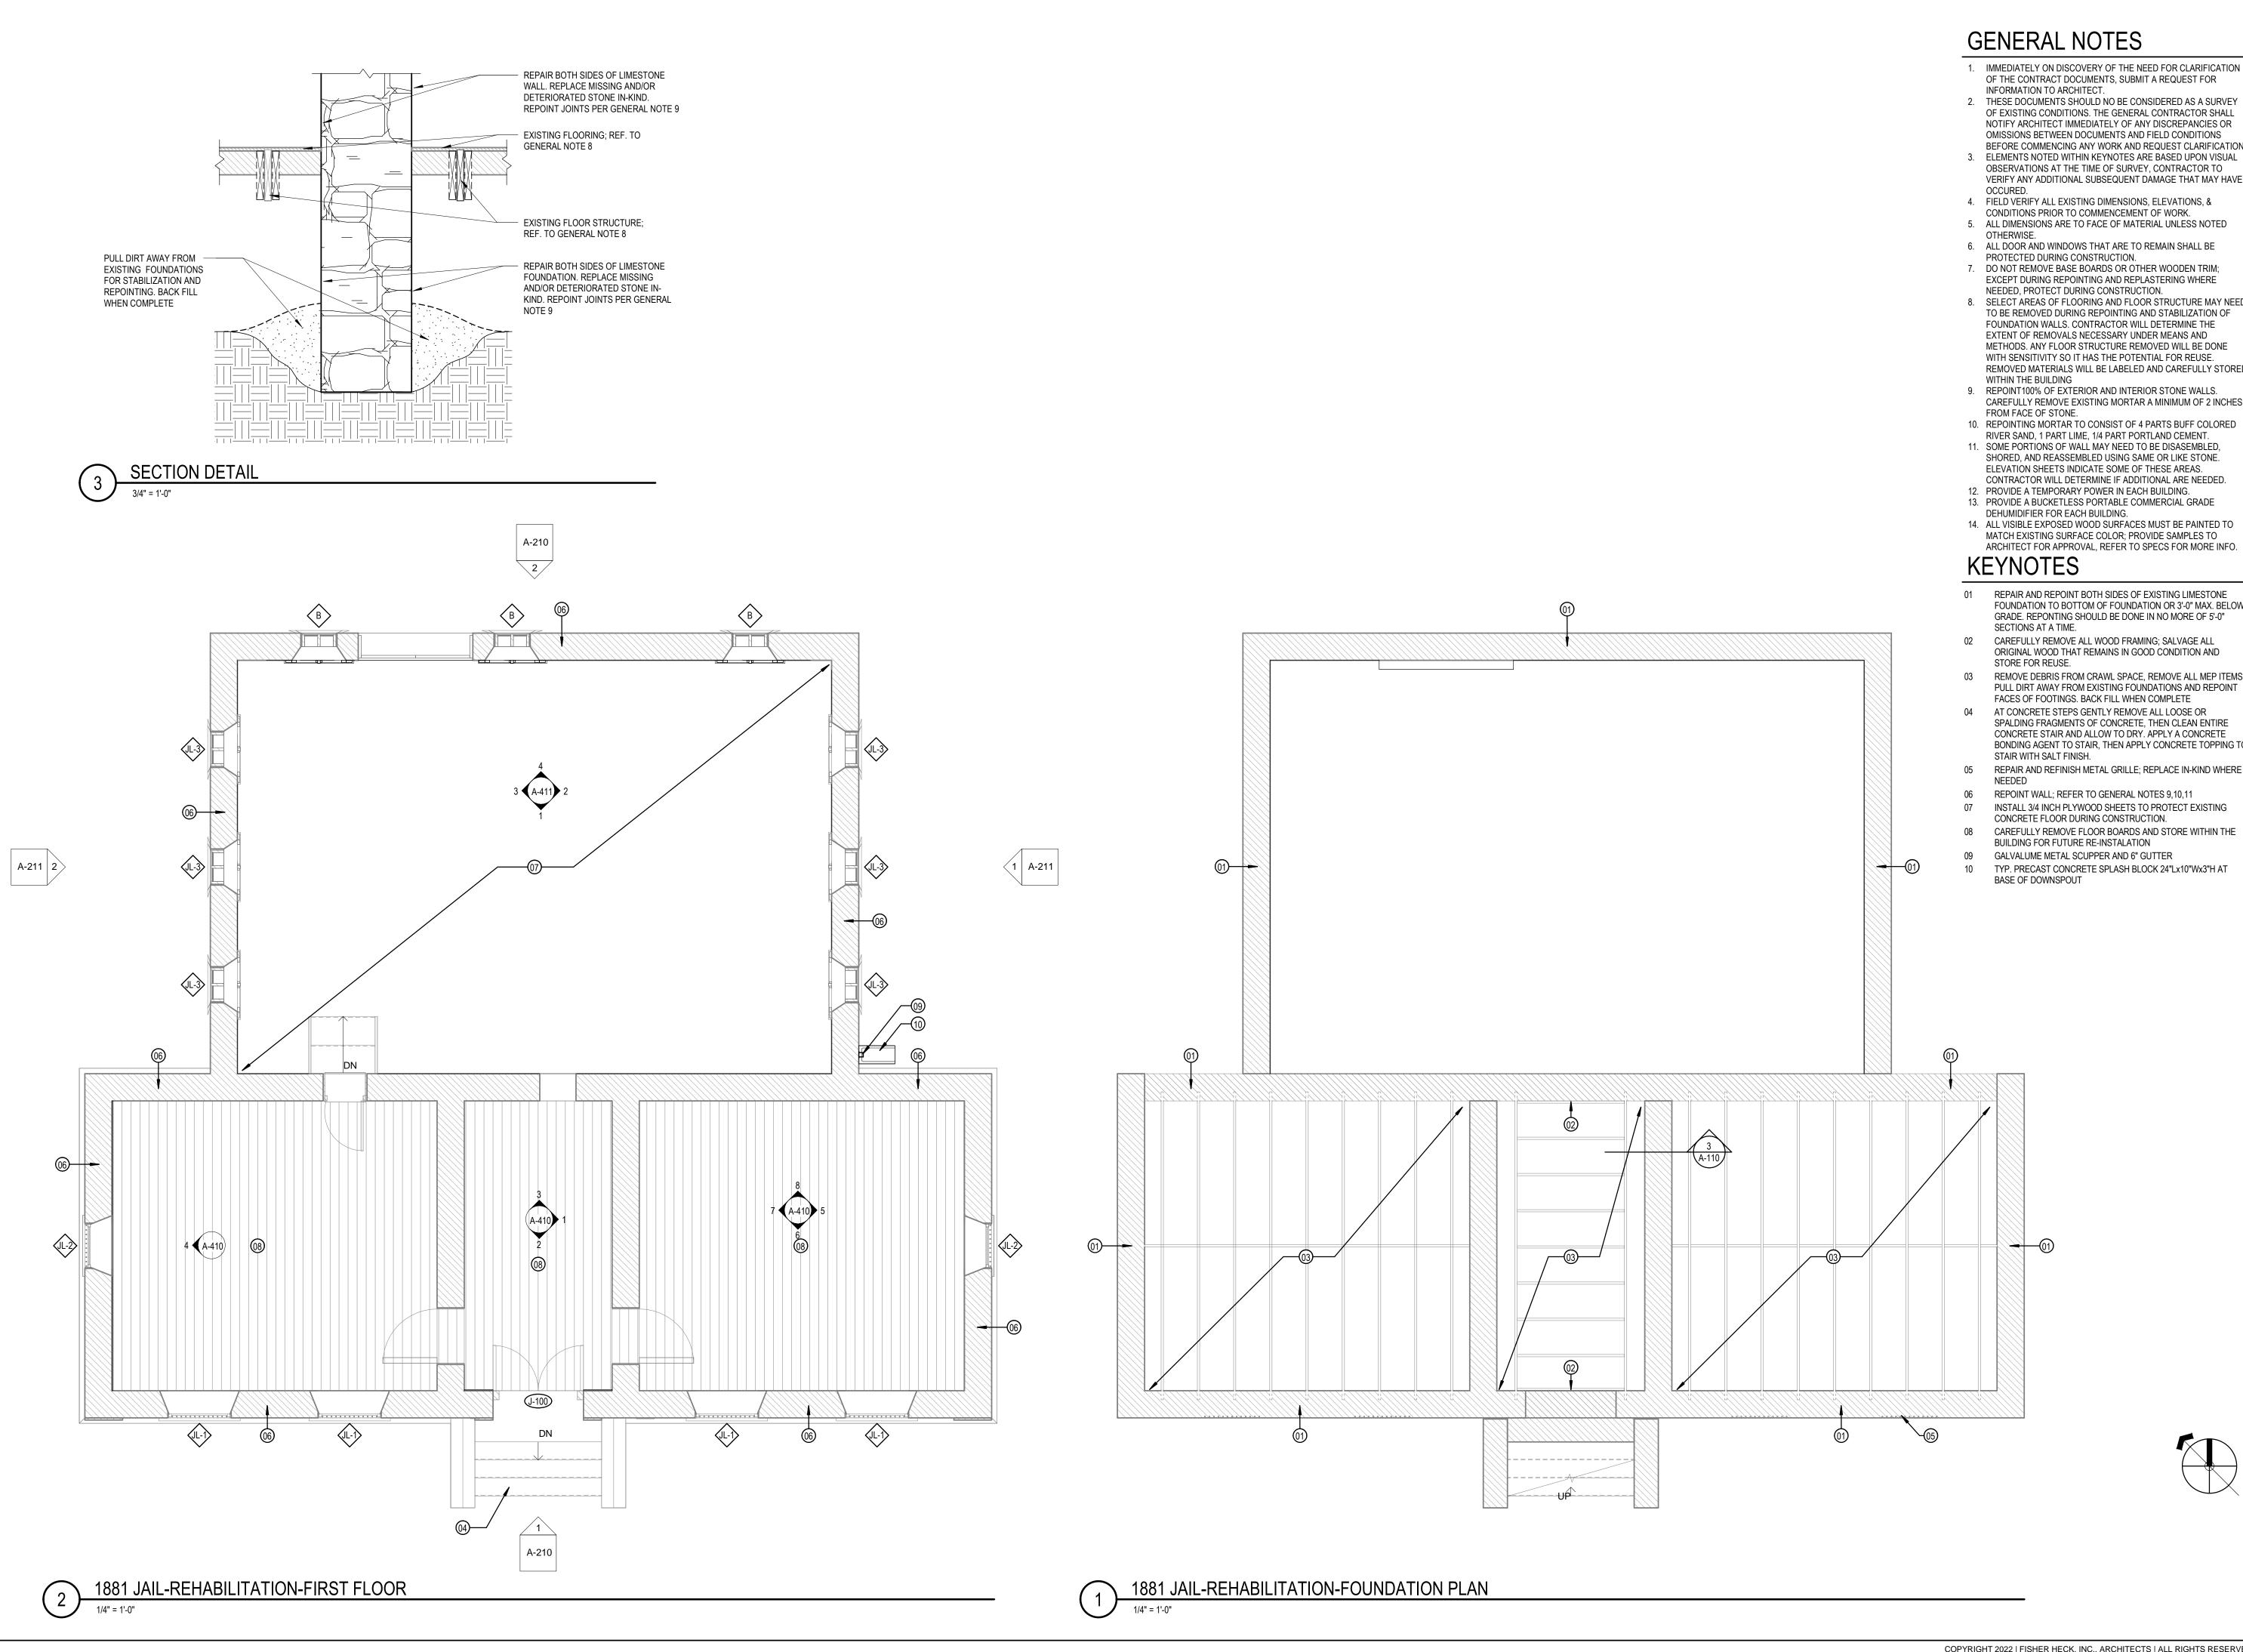
COUNTY VISITOR

BANDERA

PROJECT NO: 2301 A1

A REVISIONS DATE



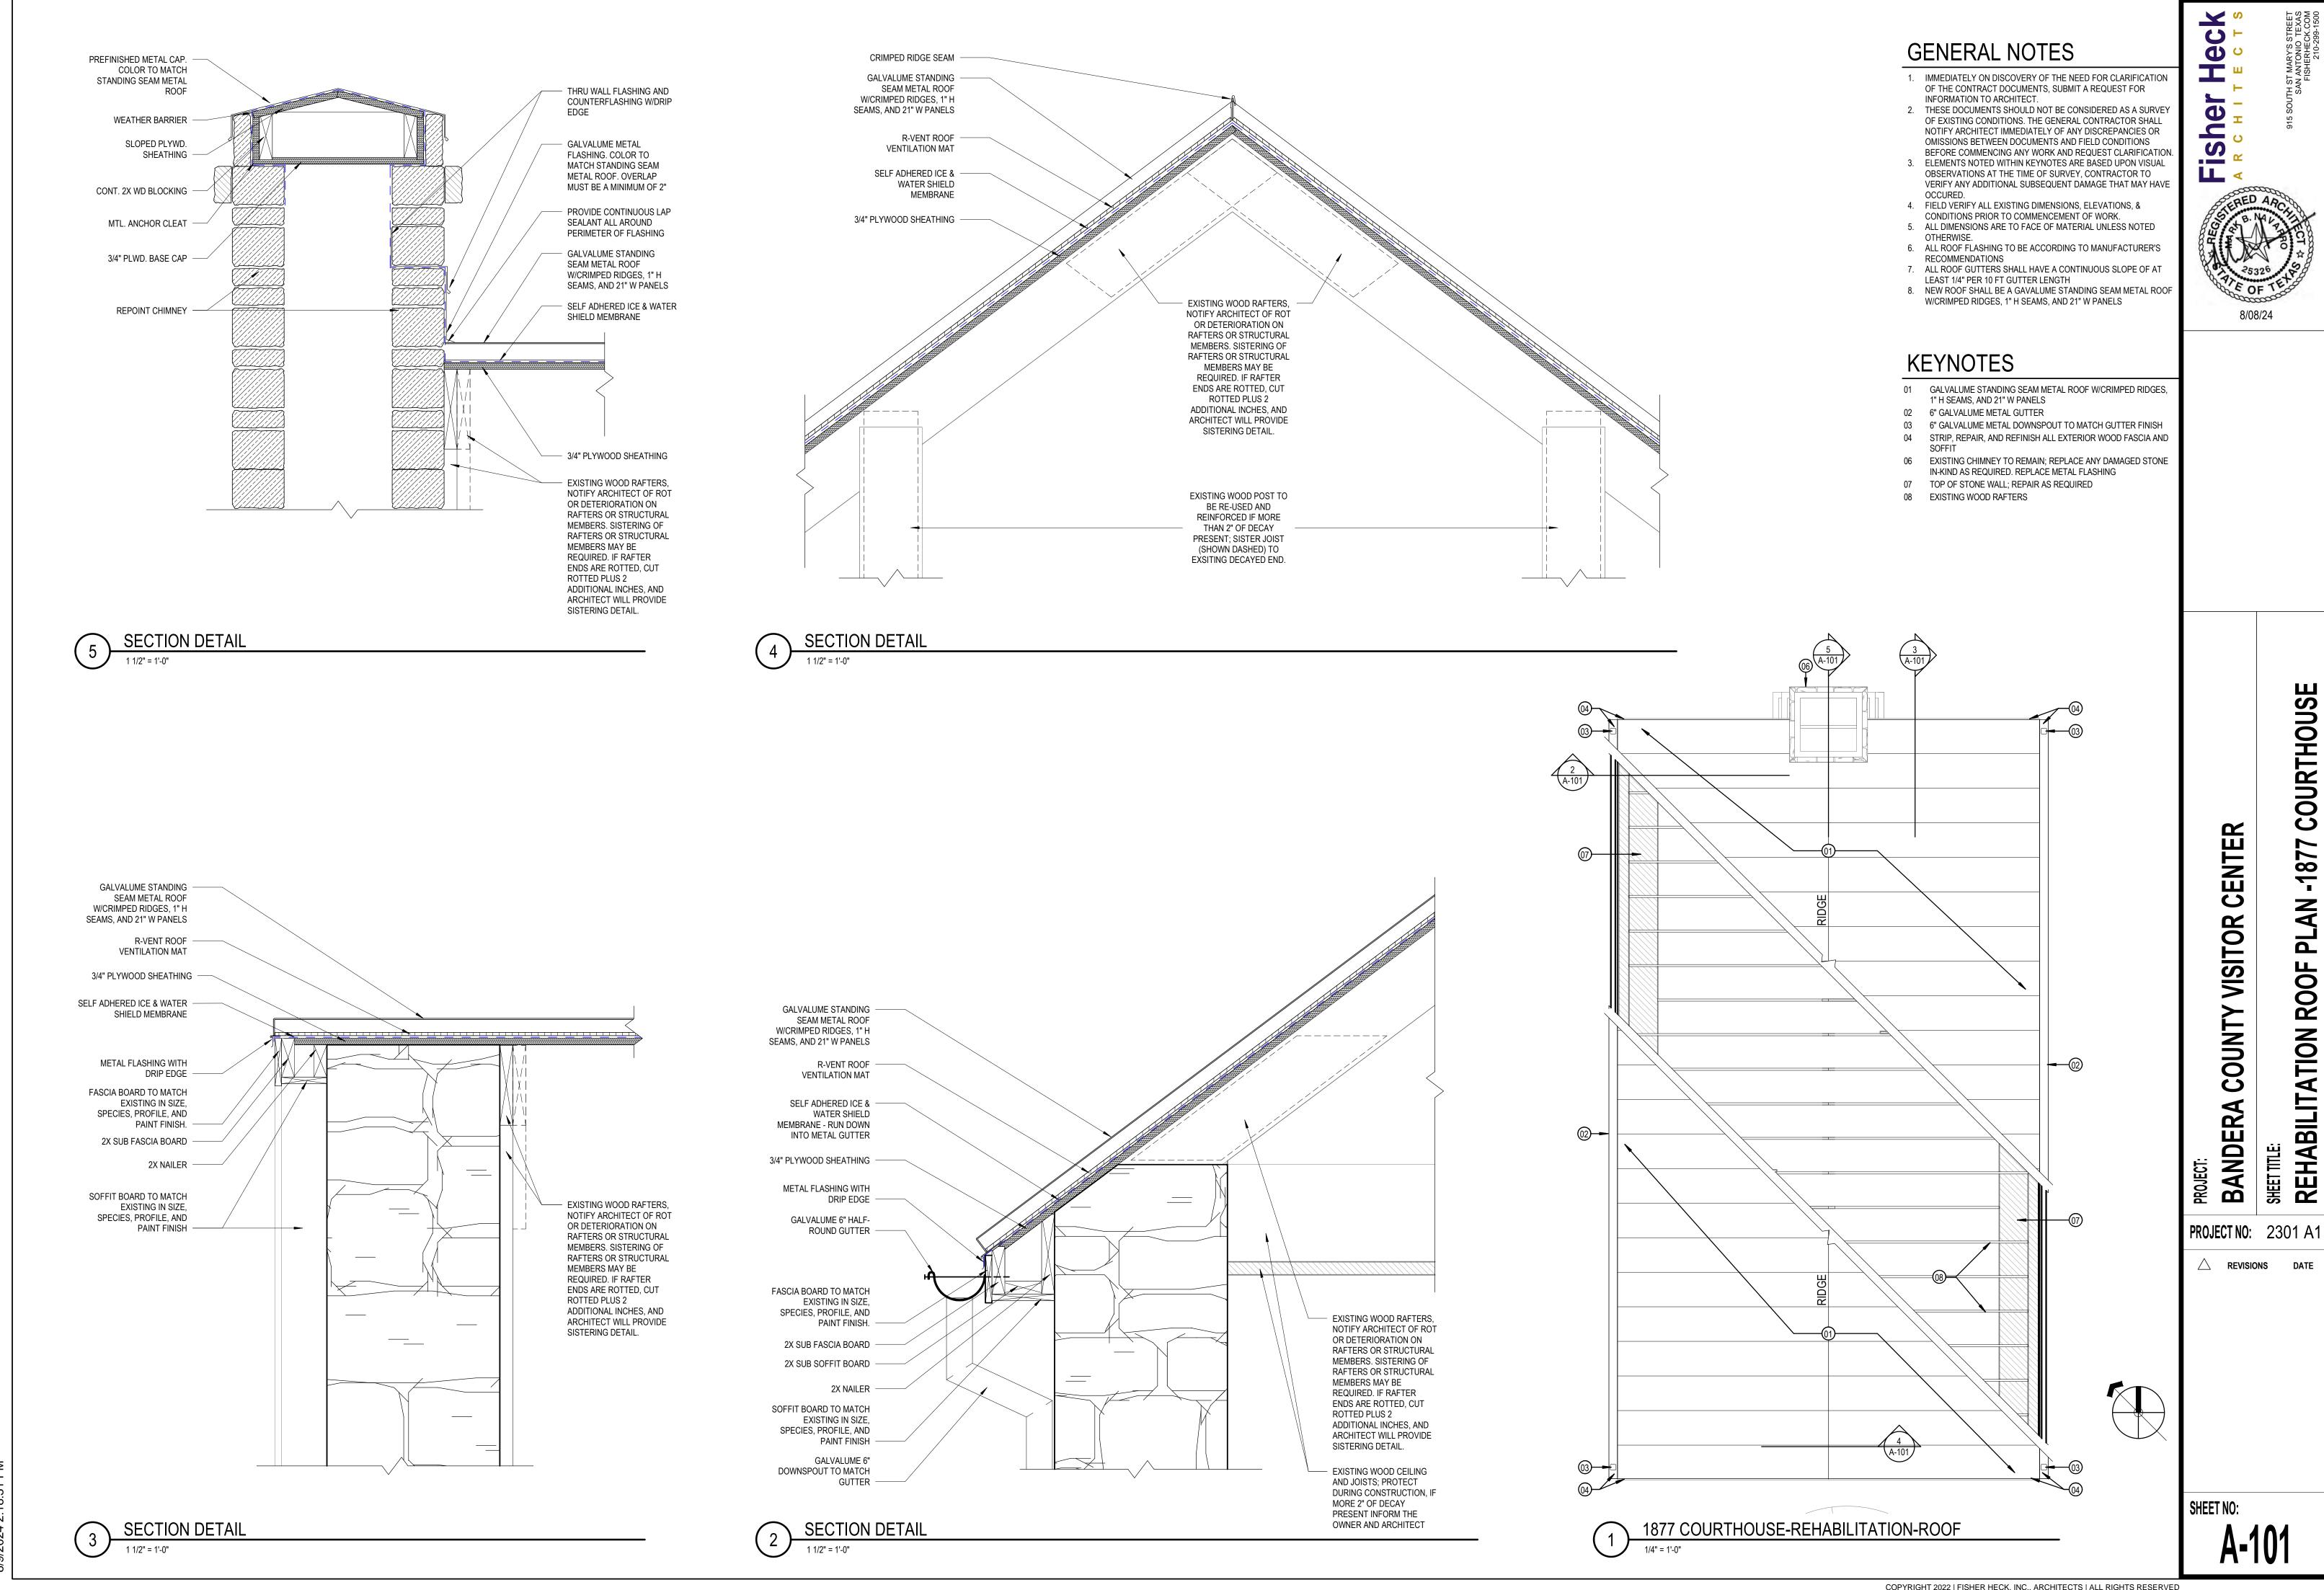

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2. THESE DOCUMENTS SHOULD NO BE CONSIDERED AS A SURVEY OF EXISTING CONDITIONS. THE GENERAL CONTRACTOR SHALL NOTIFY ARCHITECT IMMEDIATELY OF ANY DISCREPANCIES OR OMISSIONS BETWEEN DOCUMENTS AND FIELD CONDITIONS

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BEFORE COMMENCING ANY WORK AND REQUEST CLARIFICATION. 3. ELEMENTS NOTED WITHIN KEYNOTES ARE BASED UPON VISUAL OBSERVATIONS AT THE TIME OF SURVEY, CONTRACTOR TO

4. FIELD VERIFY ALL EXISTING DIMENSIONS, ELEVATIONS, &

5. ALL DIMENSIONS ARE TO FACE OF MATERIAL UNLESS NOTED

7. DO NOT REMOVE BASE BOARDS OR OTHER WOODEN TRIM;

8. SELECT AREAS OF FLOORING AND FLOOR STRUCTURE MAY NEED TO BE REMOVED DURING REPOINTING AND STABILIZATION OF FOUNDATION WALLS. CONTRACTOR WILL DETERMINE THE EXTENT OF REMOVALS NECESSARY UNDER MEANS AND METHODS. ANY FLOOR STRUCTURE REMOVED WILL BE DONE WITH SENSITIVITY SO IT HAS THE POTENTIAL FOR REUSE. REMOVED MATERIALS WILL BE LABELED AND CAREFULLY STORED

9. REPOINT100% OF EXTERIOR AND INTERIOR STONE WALLS. CAREFULLY REMOVE EXISTING MORTAR A MINIMUM OF 2 INCHES

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11. SOME PORTIONS OF WALL MAY NEED TO BE DISASEMBLED, SHORED, AND REASSEMBLED USING SAME OR LIKE STONE. ELEVATION SHEETS INDICATE SOME OF THESE AREAS.

12. PROVIDE A TEMPORARY POWER IN EACH BUILDING. 13. PROVIDE A BUCKETLESS PORTABLE COMMERCIAL GRADE

14. ALL VISIBLE EXPOSED WOOD SURFACES MUST BE PAINTED TO MATCH EXISTING SURFACE COLOR; PROVIDE SAMPLES TO

REPAIR AND REPOINT BOTH SIDES OF EXISTING LIMESTONE FOUNDATION TO BOTTOM OF FOUNDATION OR 3'-0" MAX. BELOW GRADE. REPONTING SHOULD BE DONE IN NO MORE OF 5'-0"

ORIGINAL WOOD THAT REMAINS IN GOOD CONDITION AND

03 REMOVE DEBRIS FROM CRAWL SPACE, REMOVE ALL MEP ITEMS, PULL DIRT AWAY FROM EXISTING FOUNDATIONS AND REPOINT

04 AT CONCRETE STEPS GENTLY REMOVE ALL LOOSE OR SPALDING FRAGMENTS OF CONCRETE, THEN CLEAN ENTIRE CONCRETE STAIR AND ALLOW TO DRY. APPLY A CONCRETE BONDING AGENT TO STAIR, THEN APPLY CONCRETE TOPPING TO

05 REPAIR AND REFINISH METAL GRILLE; REPLACE IN-KIND WHERE

06 REPOINT WALL; REFER TO GENERAL NOTES 9,10,11

08 CAREFULLY REMOVE FLOOR BOARDS AND STORE WITHIN THE

BUILDING FOR FUTURE RE-INSTALATION

GALVALUME METAL SCUPPER AND 6" GUTTER


TYP. PRECAST CONCRETE SPLASH BLOCK 24"Lx10"Wx3"H AT BASE OF DOWNSPOUT

BANDERA COUNTY VISITOR CENTER SHET TITLE:
REHABILITATION F

1881

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CAREFULLY DECONSTRUCT
NON-ORIGINAL BRICK MASONRY
CHIMNEY. VOID WITHIN WALL
RESULTING FROM THE
REMOVAL OF CHIMNEY, SHALL
BE FILLED WITH MATCHING
STONE WITH A LIME BASED
MOTAR

- REPOINT WALL

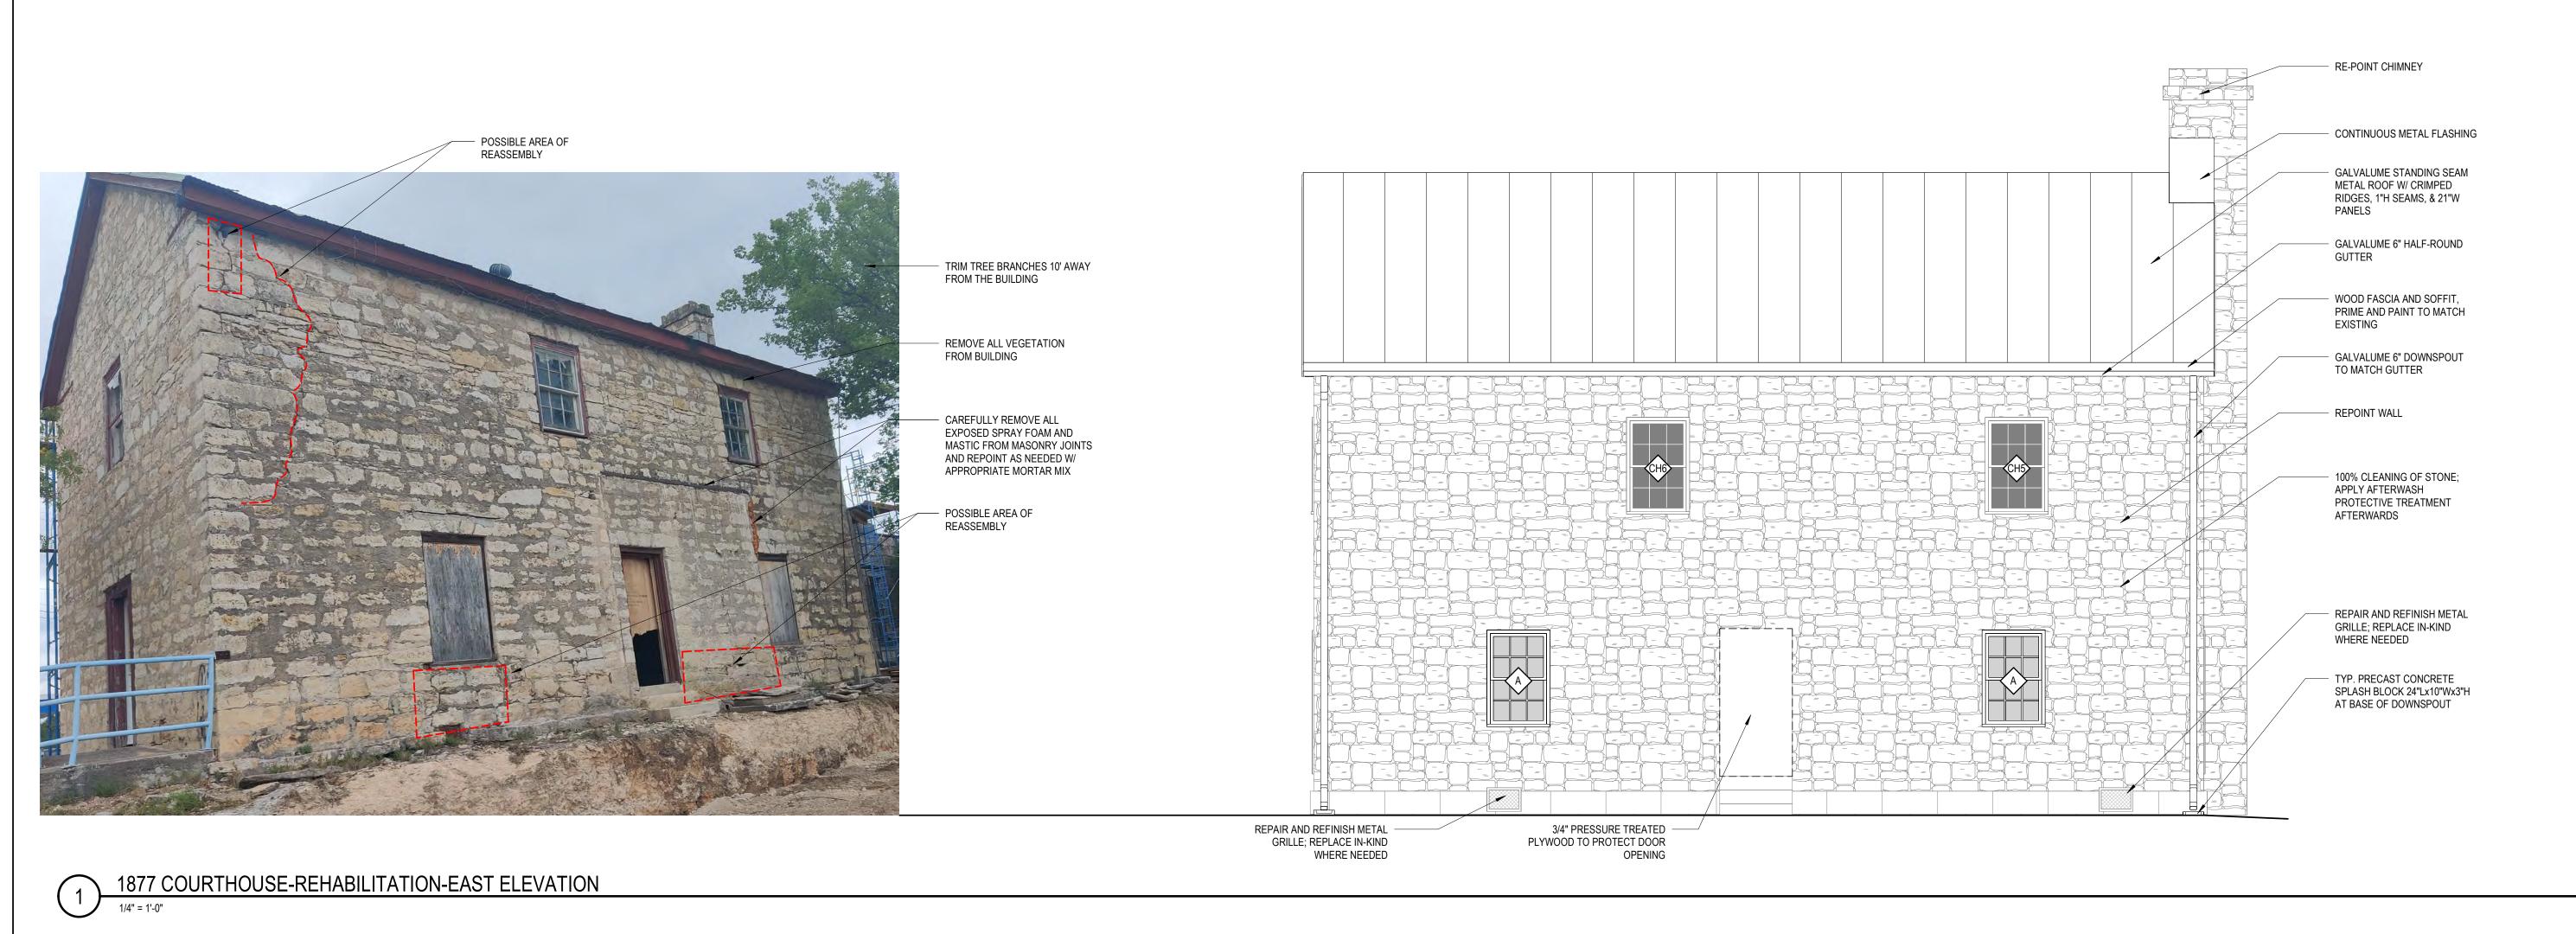TEMPORARY REMOVE
HISTORICAL PLAQUES AND
SECURELY STORE; PLACE
PLAQUES IN EXACT LOCATION
WHEN STONE WORK IS
COMPLETED

RE-POINT CHIMNEY - CONTINUOUS METAL FLASHING GALVALUME STANDING SEAM METAL ROOF W/ CRIMPED RIDGES, 1"H SEAMS, & 21"W GALVALUME 6" HALF-ROUND GUTTER - WOOD FASCIA AND SOFFIT, PRIME AND PAINT TO MATCH GALVALUME 6" DOWNSPOUT TO MATCH GUTTER REPOINT WALL - 100% CLEANING OF STONE; APPLY AFTERWASH PROTECTIVE TREATMENT AFTERWARDS TEMPORARY REMOVE HISTORICAL PLAQUES AND SECURELY STORE; PLACE PLAQUES IN EXACT LOCATION WHEN STONE WORK IS COMPLETED REPAIR AND REFINISH METAL GRILLE REPLACE IN-KIND WHERE NEEDED TYP. PRECAST CONCRETE SPLASH BLOCK 24"Lx10"Wx3"H AT BASE OF DOWNSPOUT

2 1877 COURTHOUSE-REHABILITATION-WEST ELEVATION

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ELEVATIONS


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REPOINT CHIMNEY GALVALUME STANDING SEAM -METAL ROOF W/ CRIMPED RIDGES, 1"H SEAMS, & 21"W **PANELS** WOOD FASCIA AND SOFFIT, PRIME AND PAINT TO MATCH **EXISTING** GALVALUME 6" HALF-ROUND -GUTTER GALVALUME 6" DOWNSPOUT TO MATCH GUTTER CAREFULLY DECONSTRUCT ROOF REMNANT. VOID WITHIN WALL THAT RESULTS FROM THE REMOVAL OF THE ROOF, SHALL BE FILLED WITH MATCHING STONE WITH A LIME-BASE REPOINT WALL -100% CLEANING OF STONE; UNINSTALL ELECTRICAL TO APPLY AFTERWASH PROTECTIVE TREATMENT REPOINT WALL; ONLY REINSTALL ELECTRICAL NEEDED AFTERWARDS TO CONTINUE WORK 3/4" PRESSURE TREATED -PLYWOOD TO PROTECT DOOR OPENING TYP. PRECAST CONCRETE -SPLASH BLOCK 24"Lx10"Wx3"H AT BASE OF DOWNSPOUT

1877 COURTHOUSE-REHABILITATION-NORTH ELEVATION




REPAIR MASONRY CHIMNEY BY REPAIRING CRACKS IN
LIMESTONE AND RE-POINT
STONE SURFACES, REPLACE
ANY MISSING STONES; MORTAR
TO MATCH EXISTING IN JOINT DIMENSION AND SURFACE CONTINUOUS METAL FLASHING — GALVALUME STANDING SEAM METAL ROOF W/ CRIMPED RIDGES, 1"H SEAMS, & 21"W WOOD FASCIA AND SOFFIT, PRIME AND PAINT TO MATCH EXISTING - GALVALUME 6" HALF-ROUND GUTTER - GALVALUME 6" DOWNSPOUT TO MATCH GUTTER REPOINT WALL 100% CLEANING OF STONE;
 APPLY AFTERWASH
 PROTECTIVE TREATMENT
 AFTERWARDS REMOVE GRAFFITI TYP. PRECAST CONCRETE
 SPLASH BLOCK 24"Lx10"Wx3"H
 AT BASE OF DOWNSPOUT

COUNTY VISITOR CENTER ELEVATIONS SHEET TITLE: **EXTERIOR** BANDERA PROJECT NO: 2301 A1 \triangle REVISIONS DATE

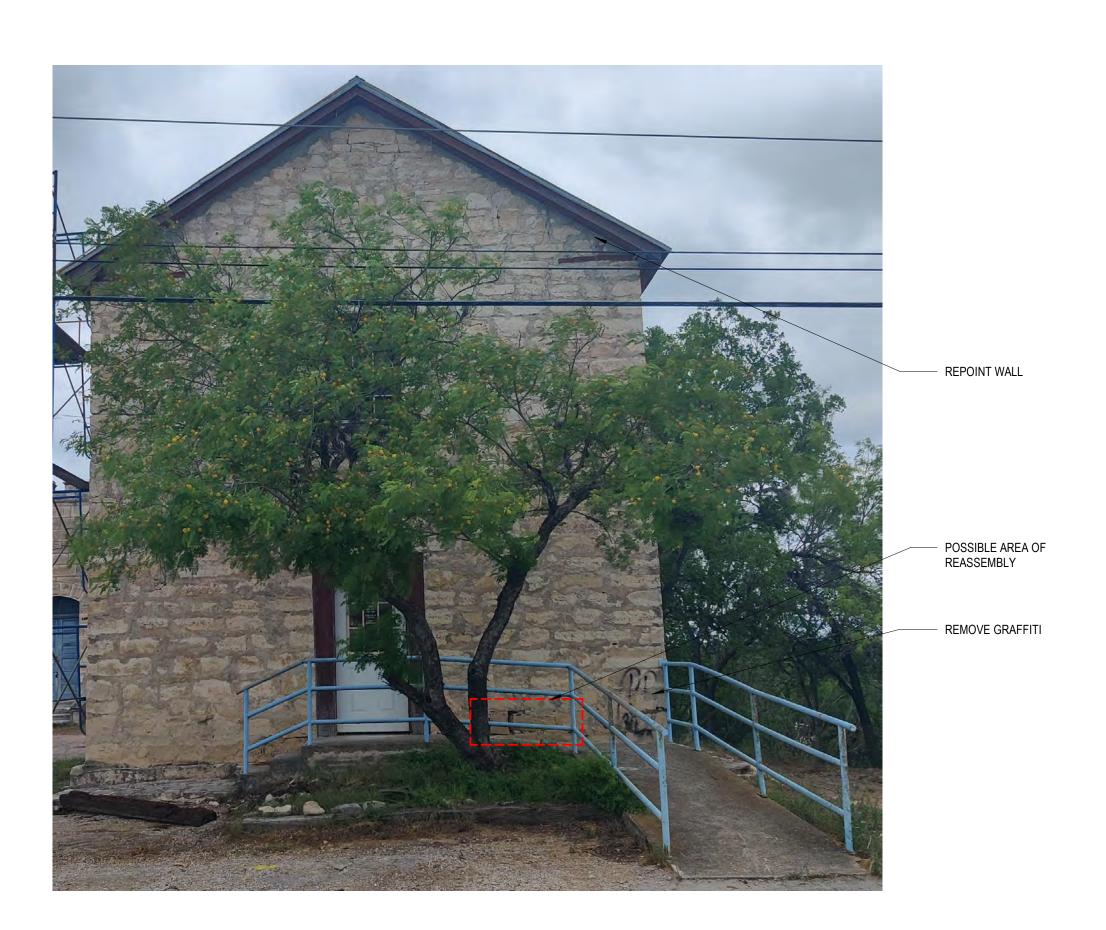
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2 1877 COURTHOUSE-REHABILITATION-SOUTH ELEVATION



2 1881 JAIL-REHABILITATION-NORTH ELEVATION

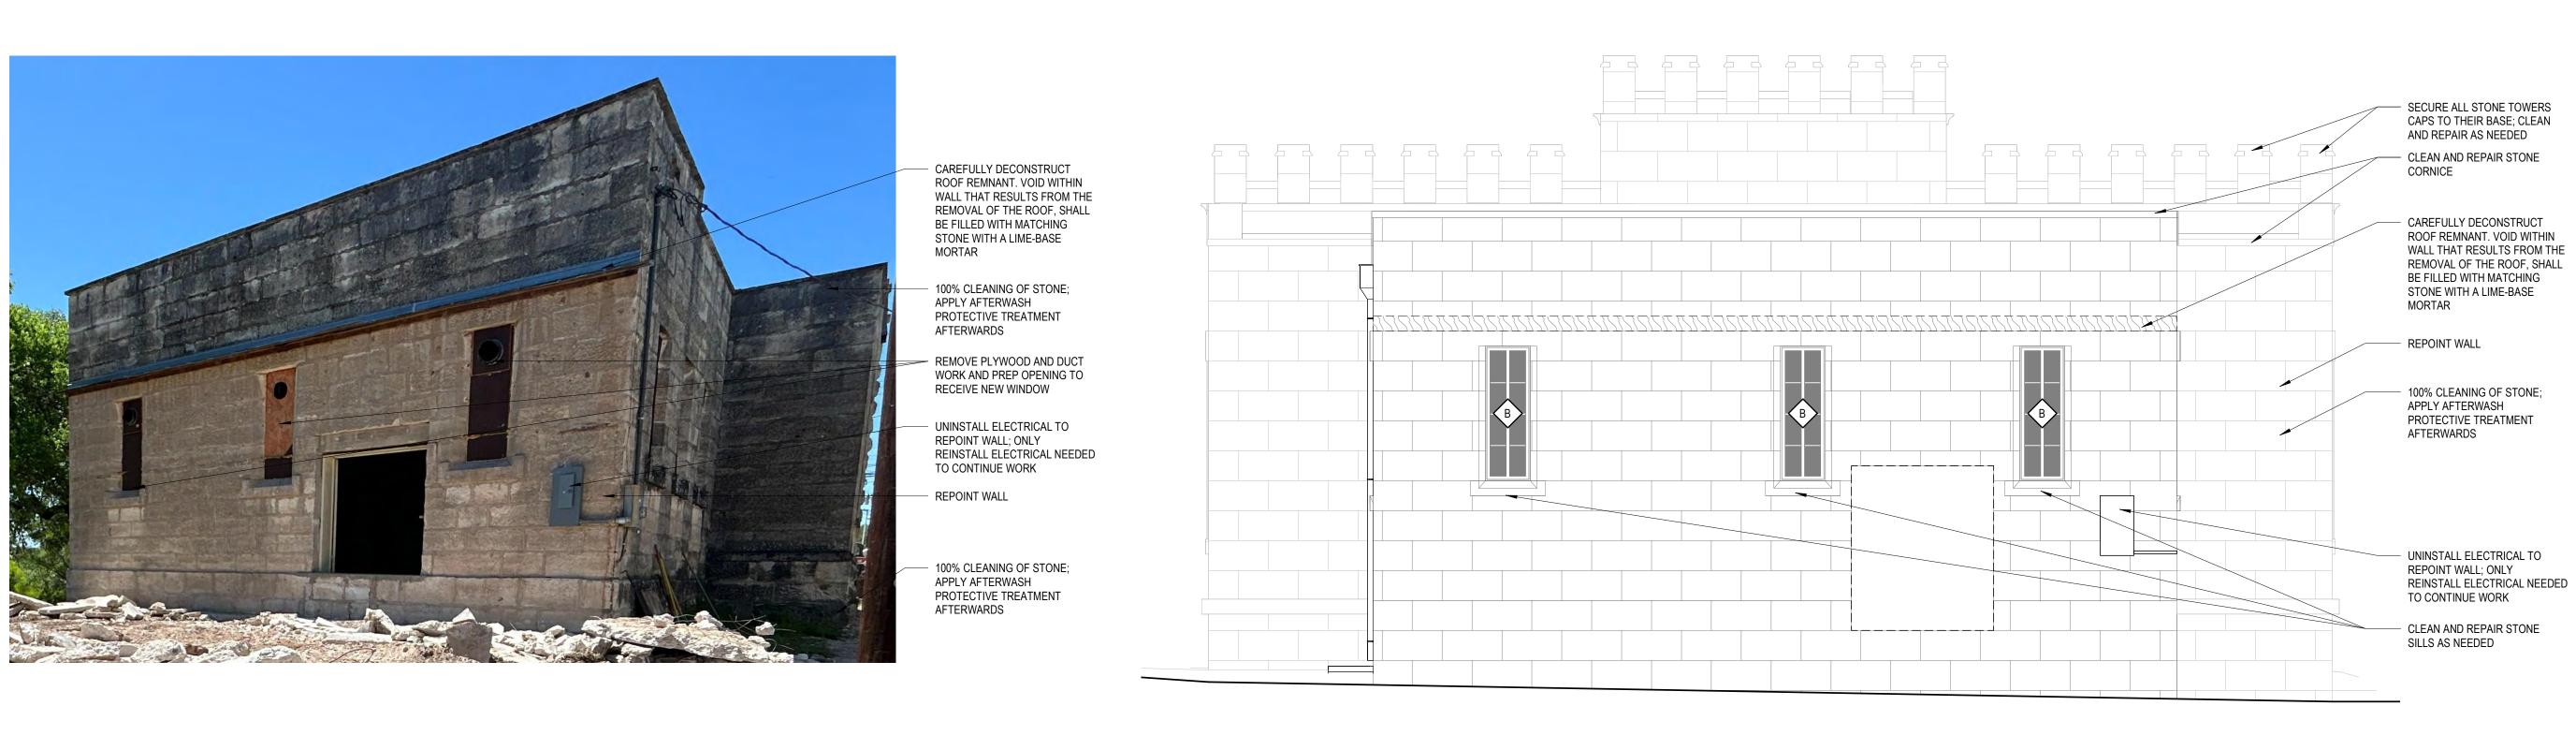

1) 1881 JAIL-REHABILITATION-SOUTH ELEVATION

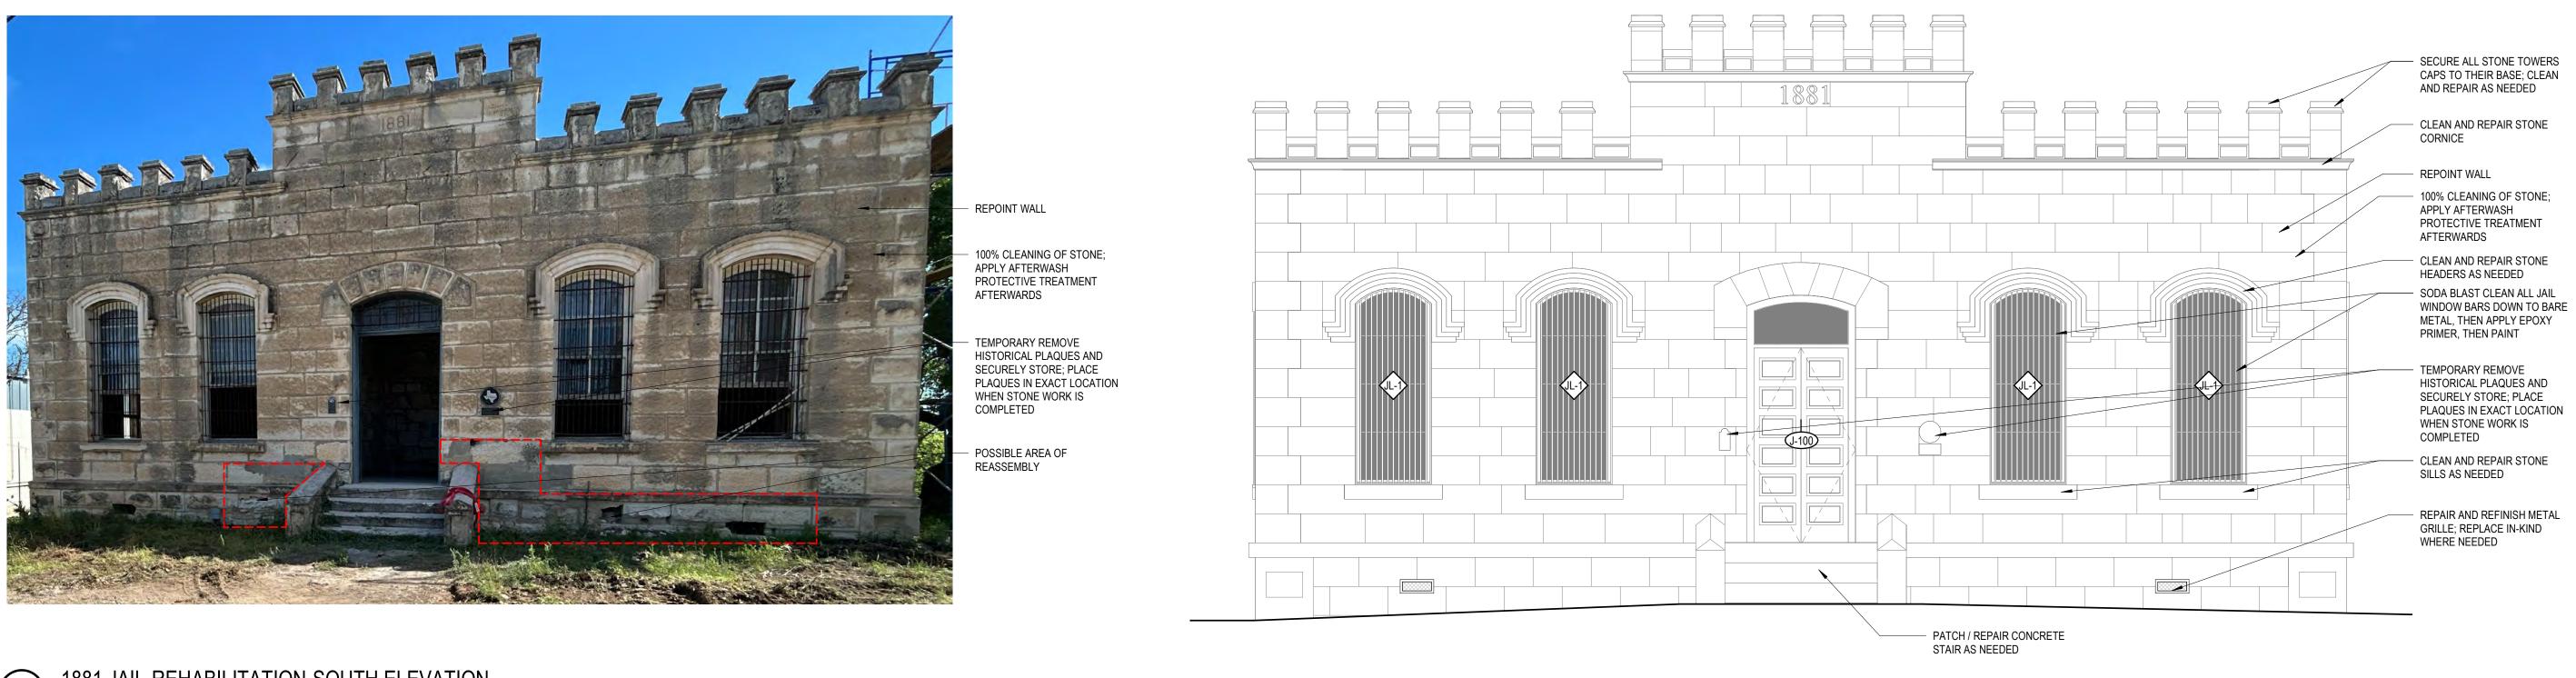SHEET NO:

COUNTY VISITOR CENTER

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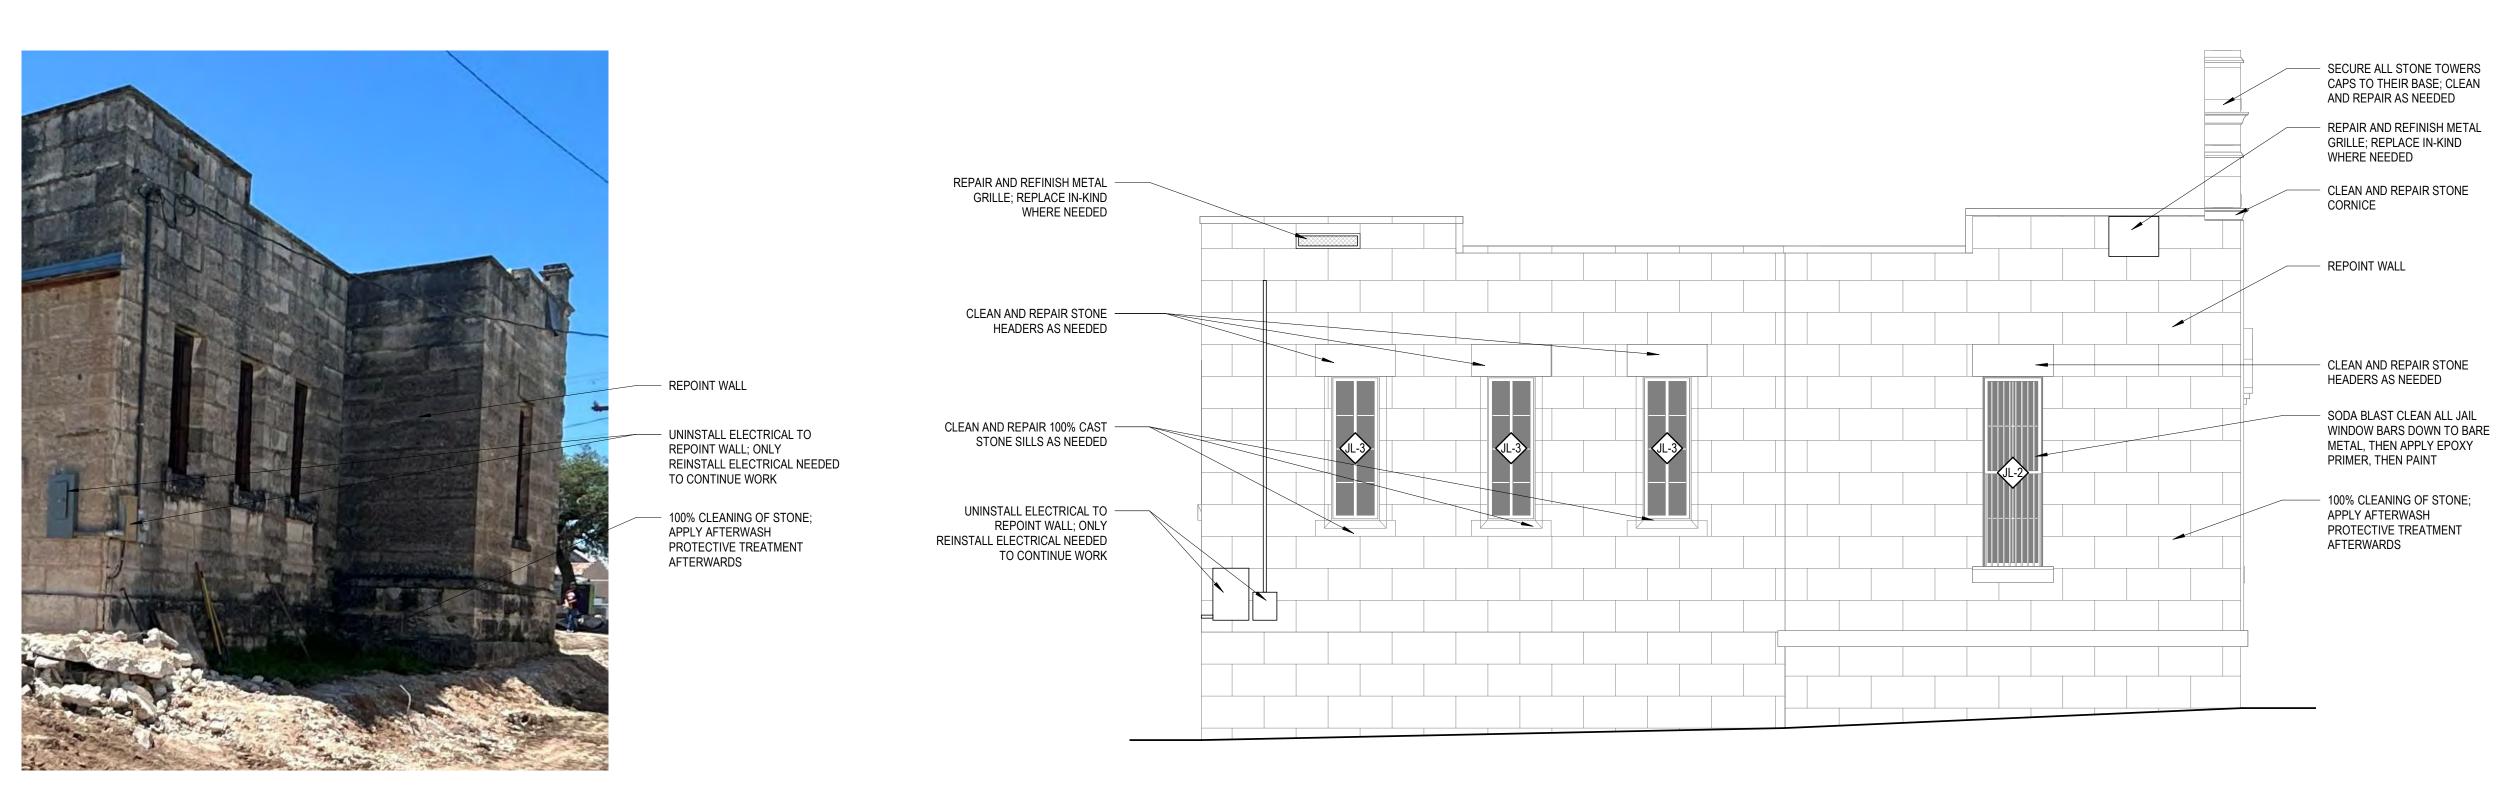
ELEVATIONS

SHEET TITLE: **EXTERIOR**

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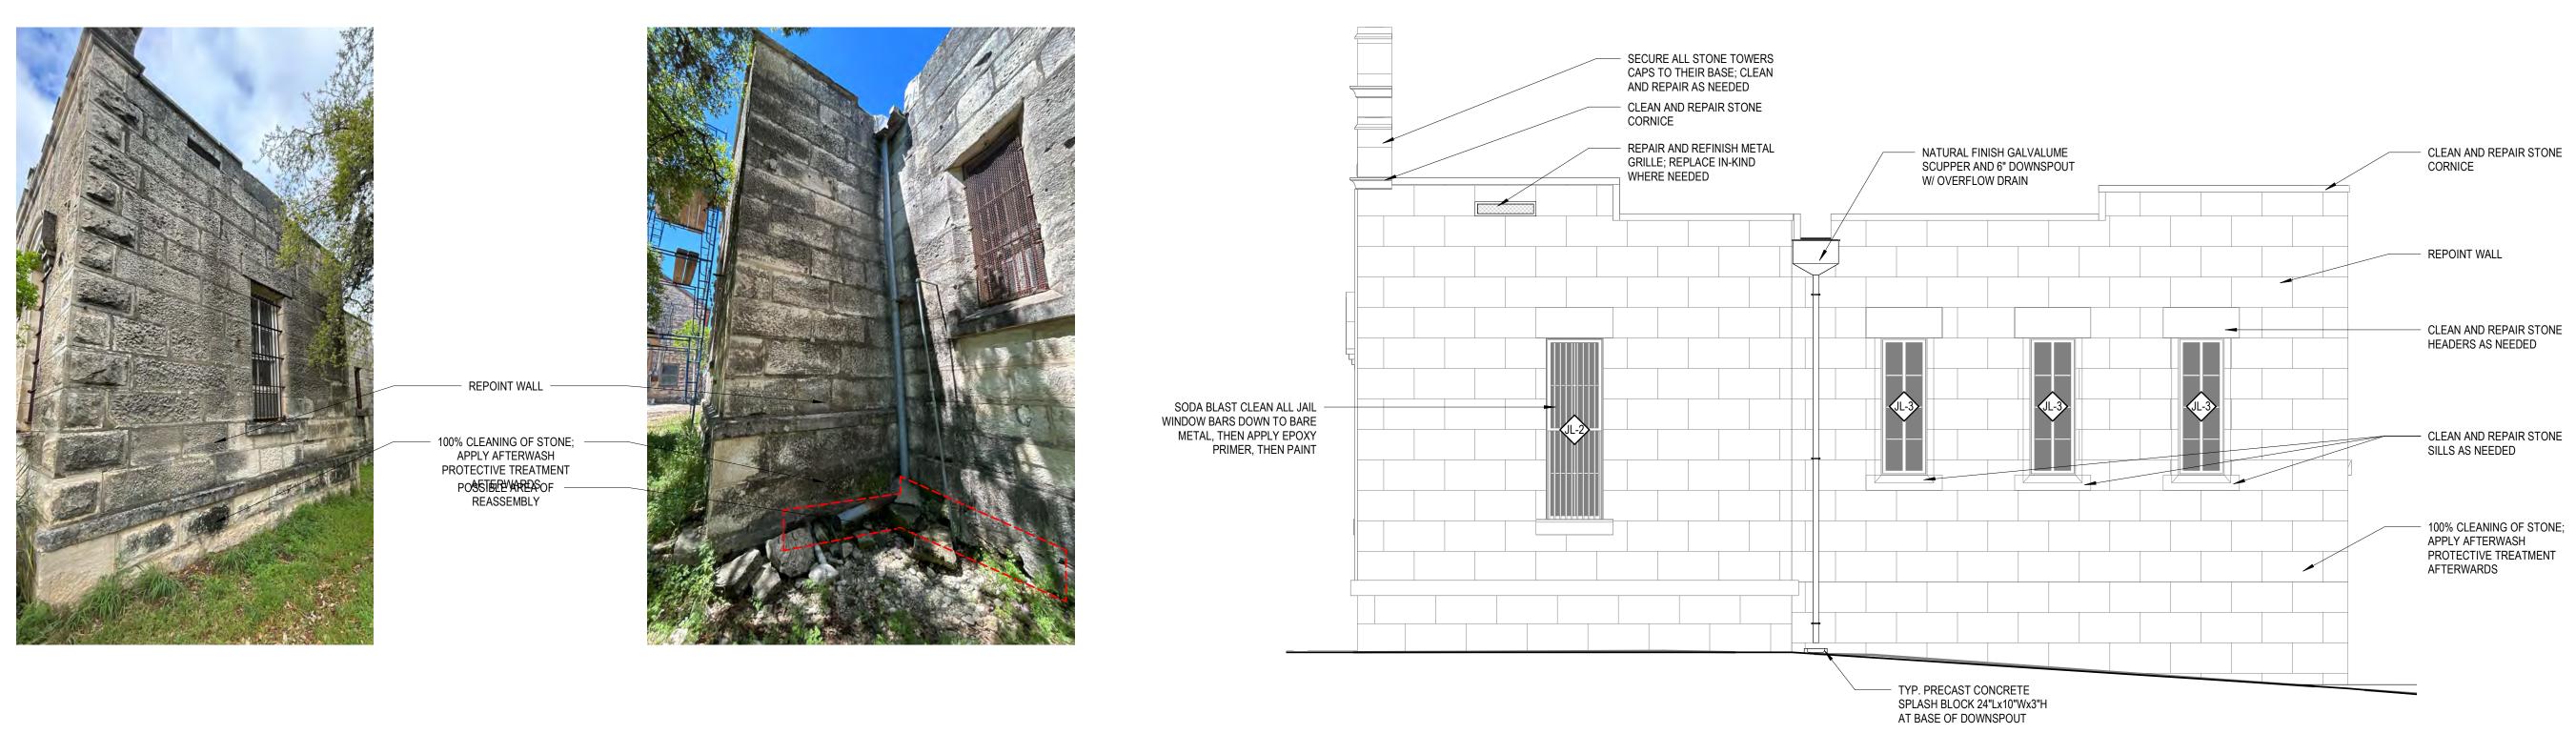
Fisher

8/08/24



2 1881 JAIL-REHABILITATION-WEST ELEVATION

1/4" = 1'-0"



1881 JAIL-REHABILITATION-EAST ELEVATION

1/4" = 1'-0"

SHEET NO:

COUNTY VISITOR CENTER

BANDERA

PROJECT NO: 2301 A1

 \triangle REVISIONS DATE

ELEVATIONS


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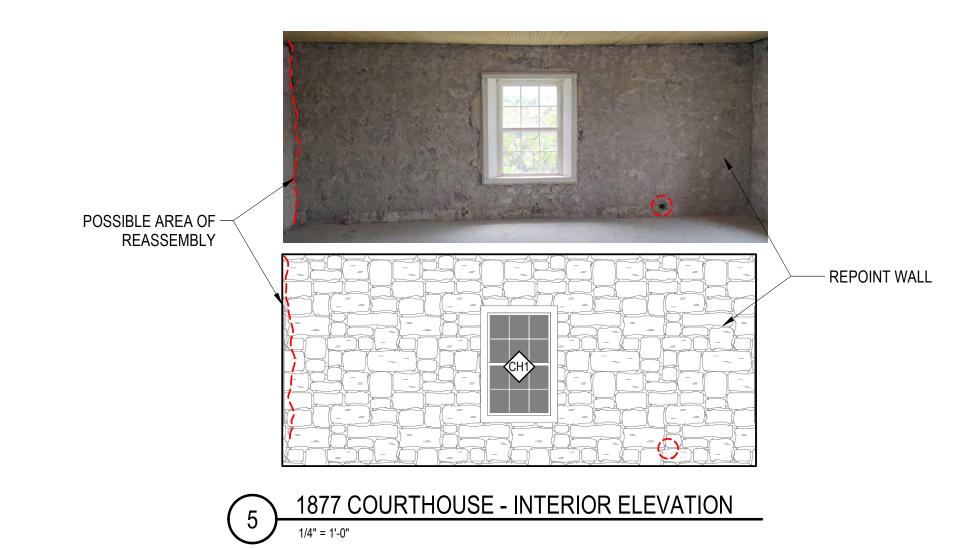
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Fisher

8/08/24









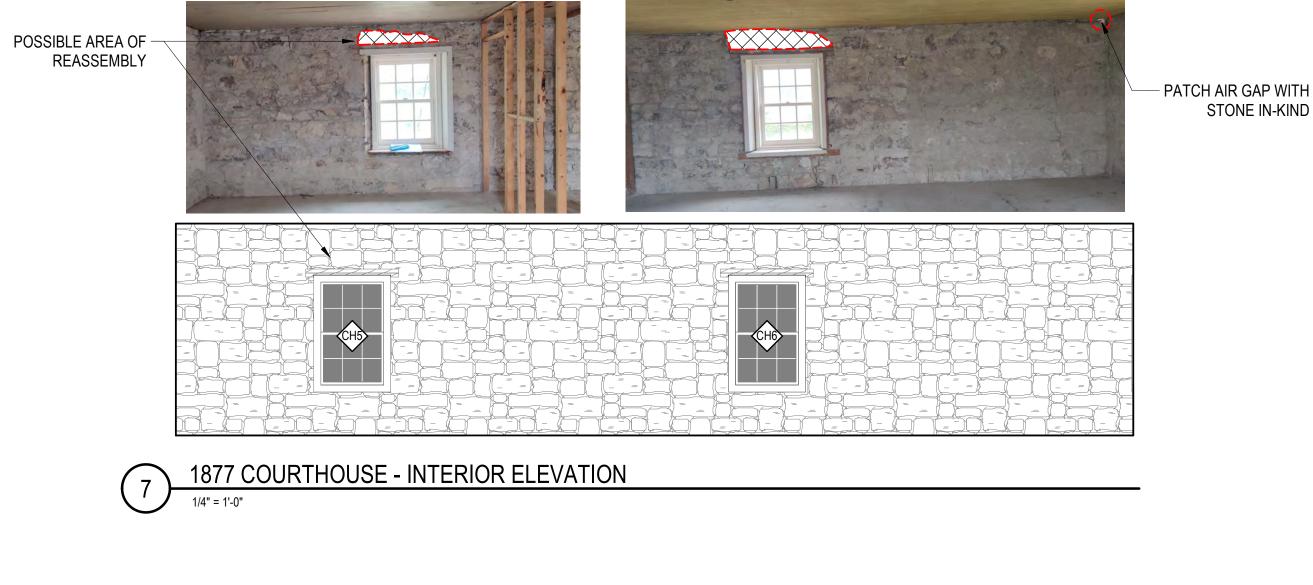

1877 COURTHOUSE - INTERIOR ELEVATION

1/4" = 1'-0"

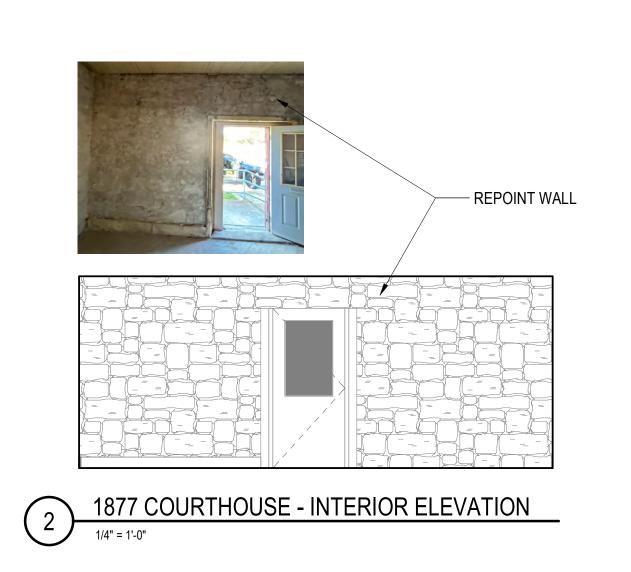


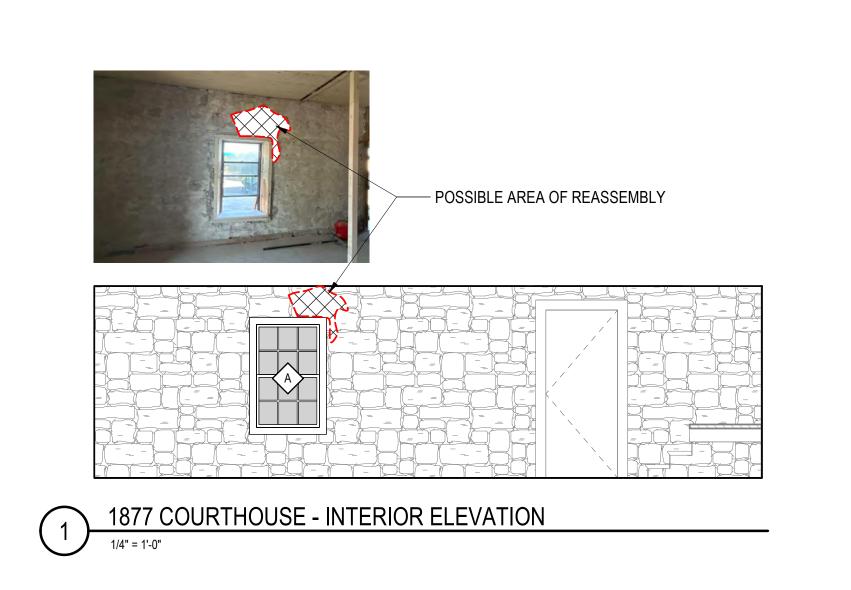

BANDERA COUNTY VISITOR CENTER SHEET TITLE:
ENLARGED ELEVATIONS PROJECT NO: 2301 A1 \triangle revisions date

Fisher ARCHIT

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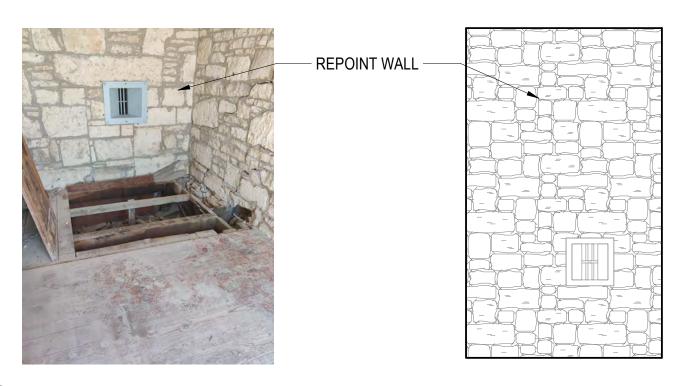
1881 JAIL - INTERIOR ELEVATION

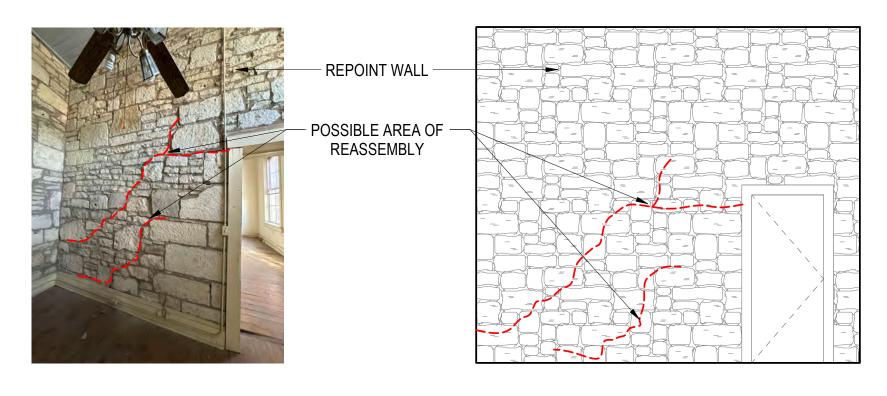1/4" = 1'-0"




2 1881 JAIL - INTERIOR ELEVATION

1/4" = 1'-0"




3 1881 JAIL - INTERIOR ELEVATION

1/4" = 1'-0"

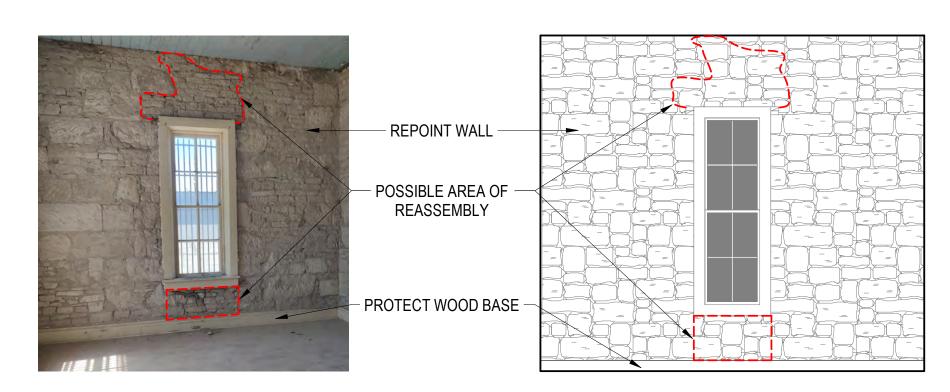


4 1881 JAIL - INTERIOR ELEVATION

1/4" = 1'-0"

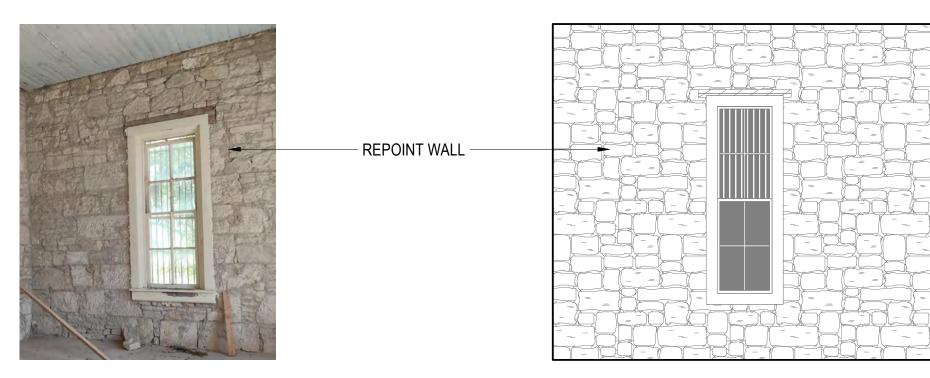


5 1881 JAIL - INTERIOR ELEVATION


1/4" = 1'-0"

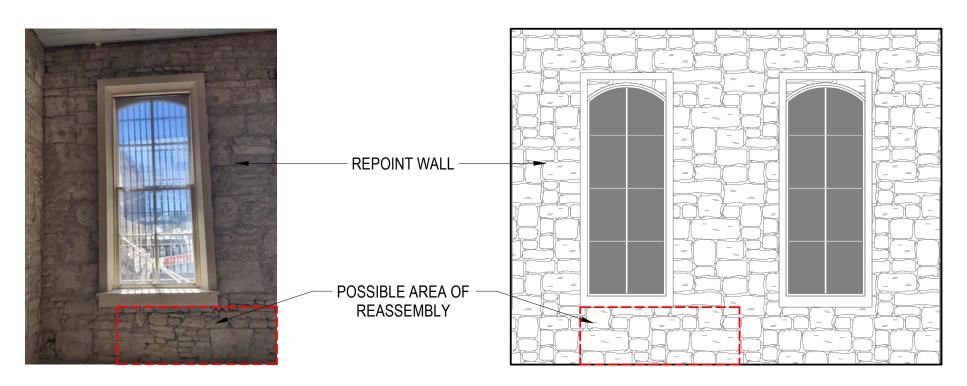

6 1881 JAIL - INTERIOR ELEVATION

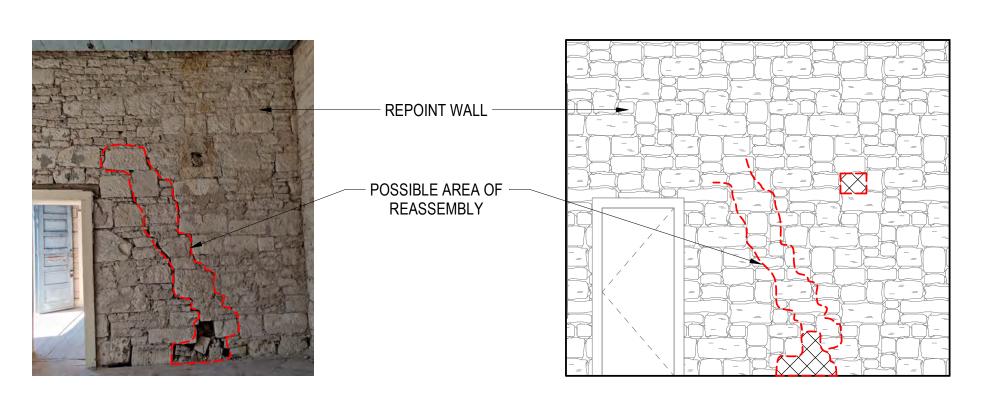

7 1881 JAIL - INTERIOR ELEVATION

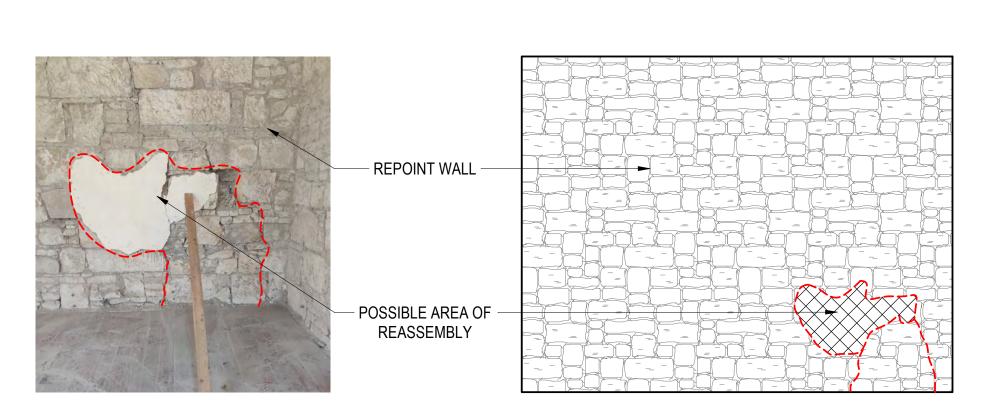

8 1881 JAIL - INTERIOR ELEVATION

1/4" = 1'-0"

FISHER HECK

A R C H I T E C T S

915 SOUTH ST MARY'S STREET
SAN ANTONIO TEXAS
FISHERHECK.COM
210-299-1500

PROJECT:

BANDERA COUNTY VISITOR CENTER

19 1005

SHETTINE:

ENLARGED ELEVATIONS

 \triangle revisions date

SHEET NO:



4 1881 JAIL - INTERIOR ELEVATION

1/4" = 1'-0"

REPOINT WALL PROTECT WINDOWS – AND WOOD SHUTTERS

– PROTECT WINDOWS – AND WOOD SHUTTERS

3 1881 JAIL - INTERIOR ELEVATION

1/4" = 1'-0"

2 1881 JAIL - INTERIOR ELEVATION

1/4" = 1'-0"

REPOINT WALL -

1881 JAIL - INTERIOR ELEVATION

1/4" = 1'-0"

SHEET NO:

PROJECT:


BANDERA COUNTY VISITOR CENTER


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ENLARGED ELEVATIONS


Fisher Heck


PROJECT NO: 2301 A1

 \triangle revisions date

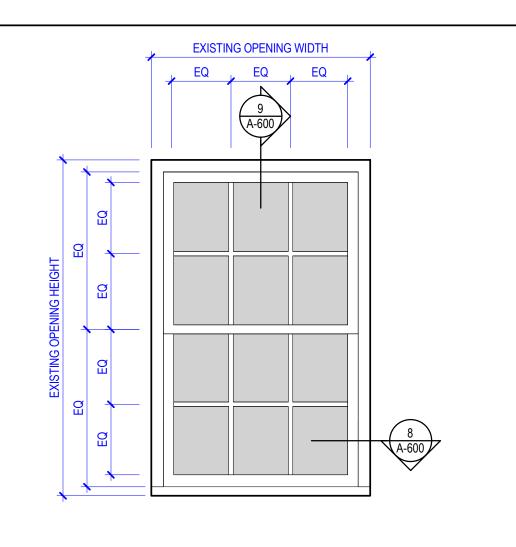

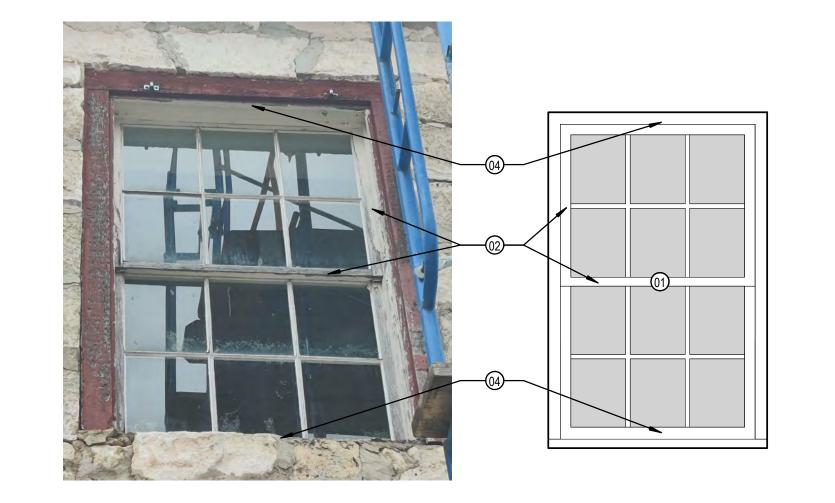

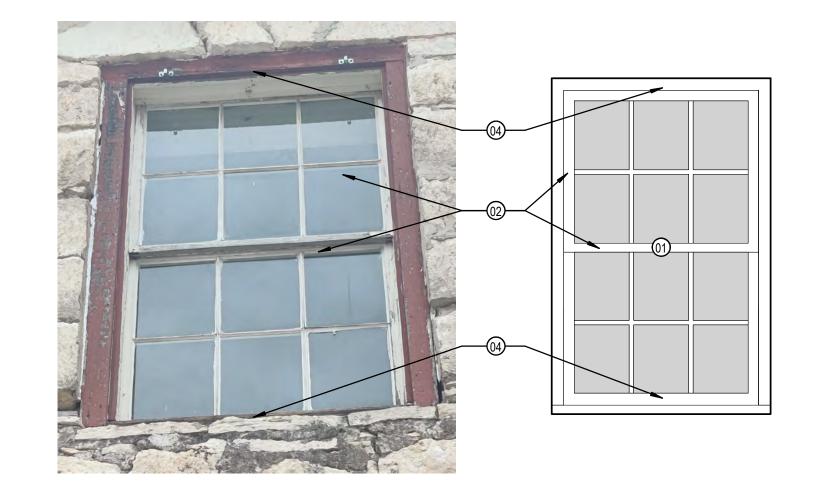


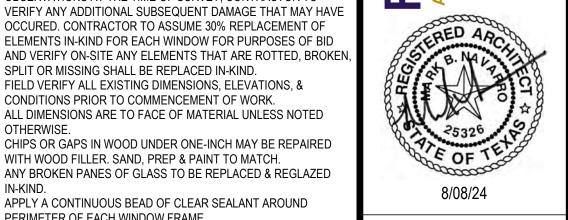


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CH-3 EXTERIOR



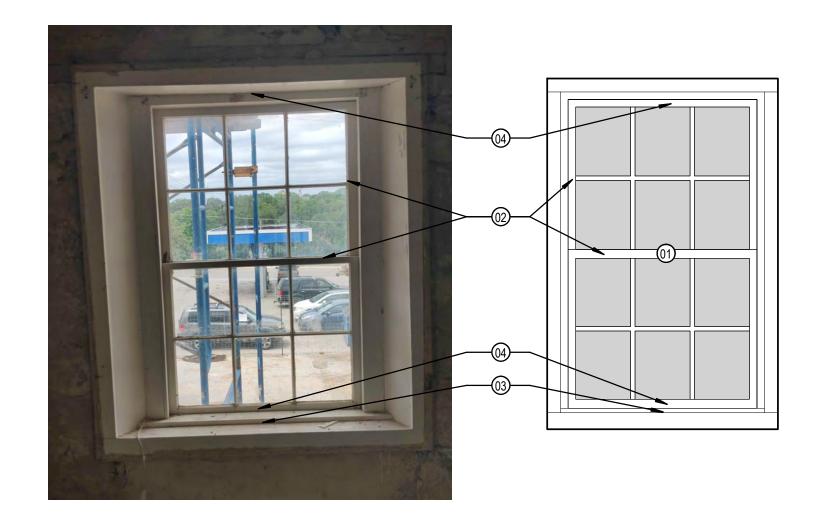

CH-1 INTERIOR

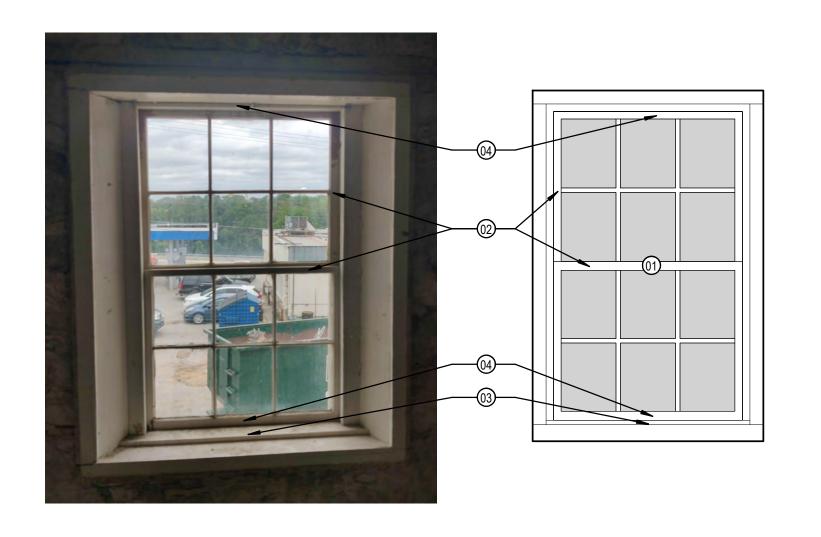WINDOW SILL DETAIL

CH-2 INTERIOR
3/4" = 1'-0"

EXTERIOR

INTERIOR

CH-3 INTERIOR
3/4" = 1'-0"

- EXISTING LIMESTONE

WINDOW STILE TO

MATCH PROFILE OF

WINDOW AS

SCHEDULE

HISTORIC WINDOWS


WINDOW FRAME TO

MATCH PROFILE OF


- WOOD FRAMING

HISTORIC WINDOWS

WALL

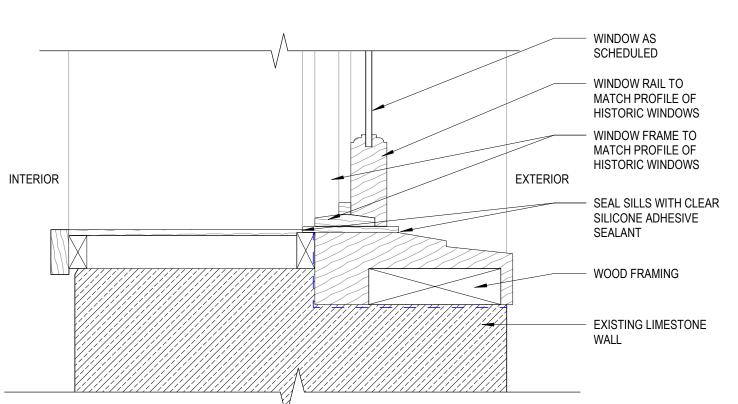

WINDOW JAMB DETAIL

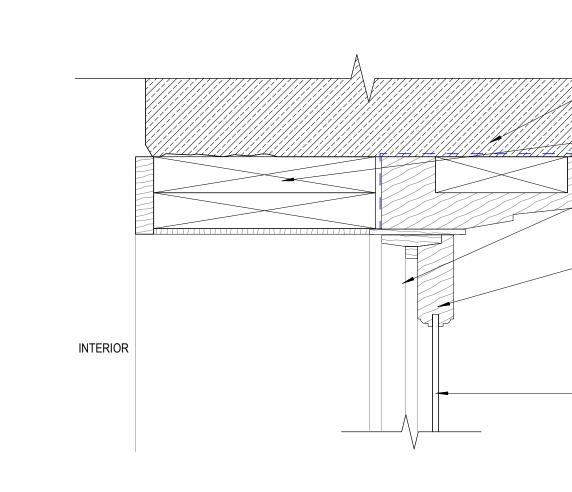

WINDOW HEAD DETAIL

KEYNOTES

GENERAL NOTES

INFORMATION TO ARCHITECT.

1. IMMEDIATELY ON DISCOVERY OF THE NEED FOR CLARIFICATION OF THE CONTRACT DOCUMENTS, SUBMIT A REQUEST FOR

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OCCURED. CONTRACTOR TO ASSUME 30% REPLACEMENT OF ELEMENTS IN-KIND FOR EACH WINDOW FOR PURPOSES OF BID

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8. APPLY A CONTINUOUS BEAD OF CLEAR SEALANT AROUND

PERIMETER OF EACH WINDOW FRAME.

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- 15 CONSTRUCT REPLICA WINDOW MATCH ADJACENT WOOD WINDOWS INKIND, SIZE AND SPECIES.
- NEW TEMPERED GLASS, MATCH EXISTING IN-KIND.

EXISTING LIMESTONE

EXISTING WD. LINTEL

WINDOW FRAME TO

MATCH PROFILE OF

HISTORIC WINDOWS

WINDOW RAIL TO MATCH PROFILE OF HISTORIC WINDOWS

WINDOW AS

SCHEDULE

EXTERIOR

WALL

- 17 NEW HARDWARE, MATCH EXISTING IN-KIND.
- 18 DEMO PLYWOOD AND DUCT WORK TO REVEAL JAIL BARS; CAREFULLY REMOVE ALL EXPOSED SPRAY FOAM AND MASTIC

COUNTY VISITOR BANDERA

CENTER

COURTHOUSE


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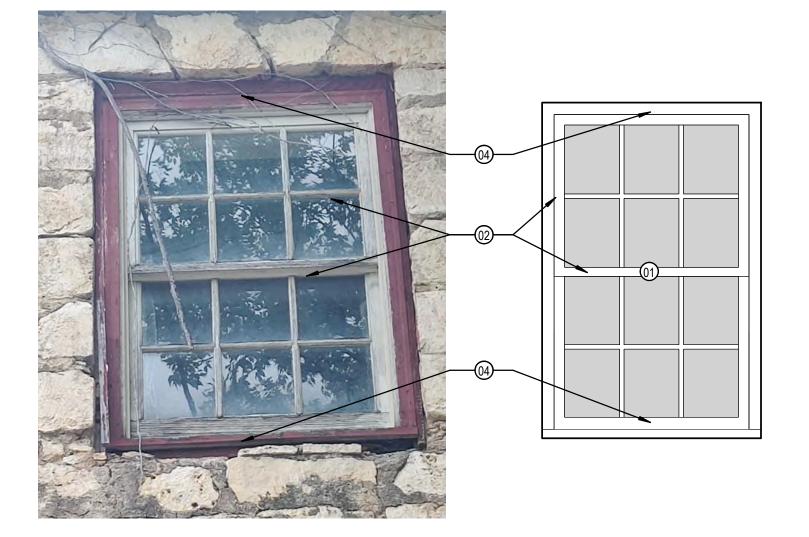
DETAILS


REHABILITATION

WINDOW PROJECT NO: 2301 A1

A REVISIONS DATE



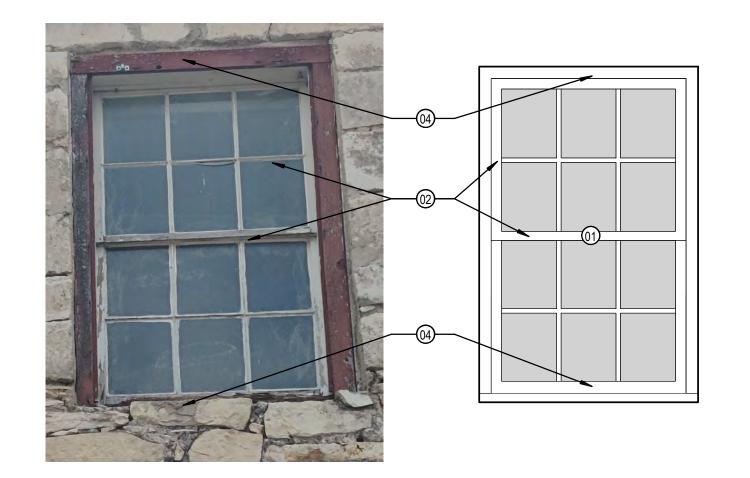


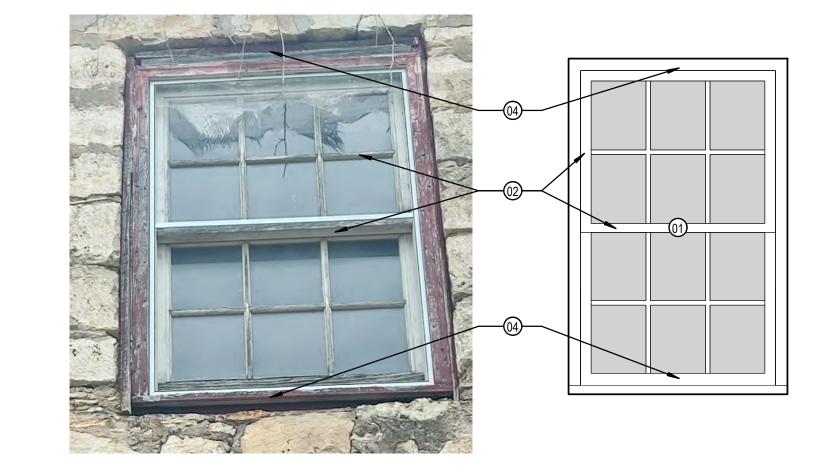



1) CH-4 EXTERIOR


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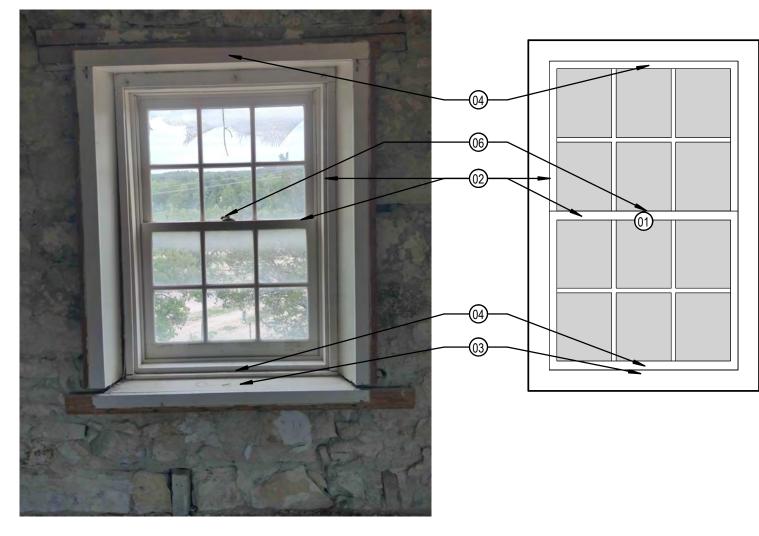
CH-6 EXTERIO



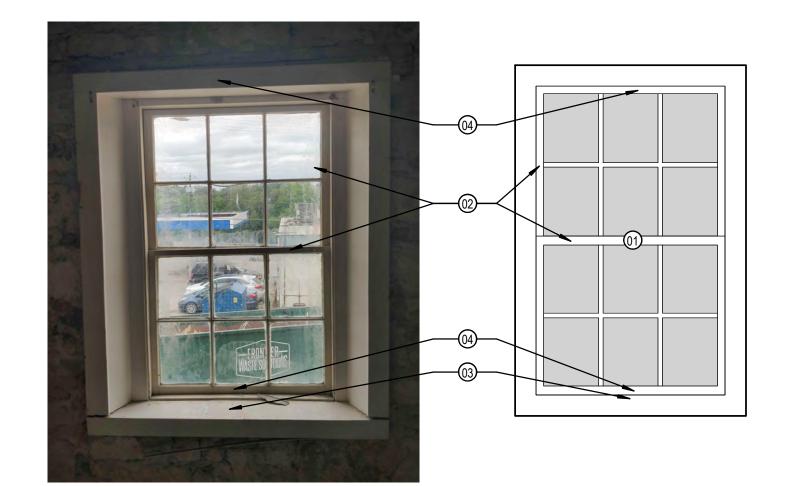

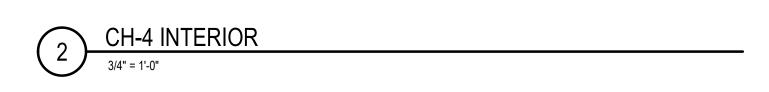

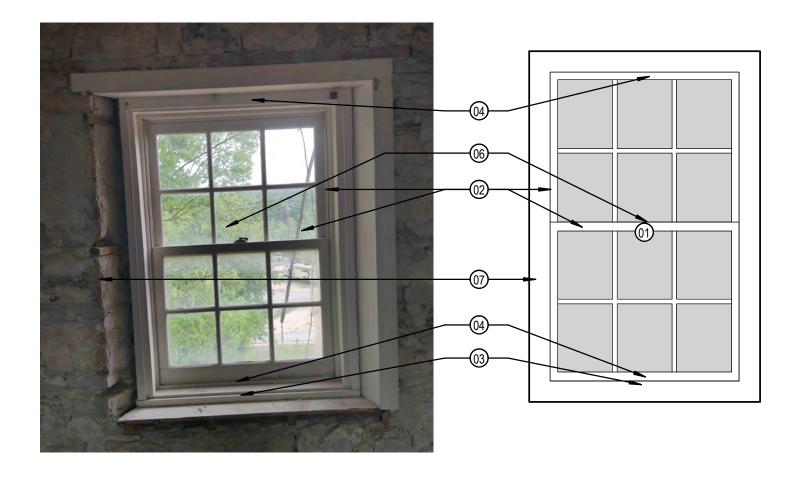

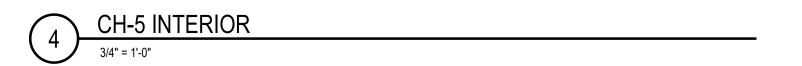

6 CH-6 INTERIOR

3/4" = 1'-0"

GENERAL NOTES

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 OF THE CONTRACT DOCUMENTS, SUBMIT A REQUEST FOR
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OMISSIONS BETWEEN DOCUMENTS AND FIELD CONDITIONS

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 CONDITIONS PRIOR TO COMMENCEMENT OF WORK.

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 CHIPS OR GAPS IN WOOD UNDER ONE-INCH MAY BE REPAIRED WITH WOOD FILLER SAND PREP & PAINT TO MATCH
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 OP SODA BLAST CLEAN ALL JAIL WINDOW BARS DOWN TO BARE
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8/08/24

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DETAILS - 1877 COURTHOUSE


BANDERA COUNTY VISITOR CENTER SHETTILE: WINDOW REHABILITATION DETAILS -

PROJECT NO: 2301 A1

DENTAL 2001


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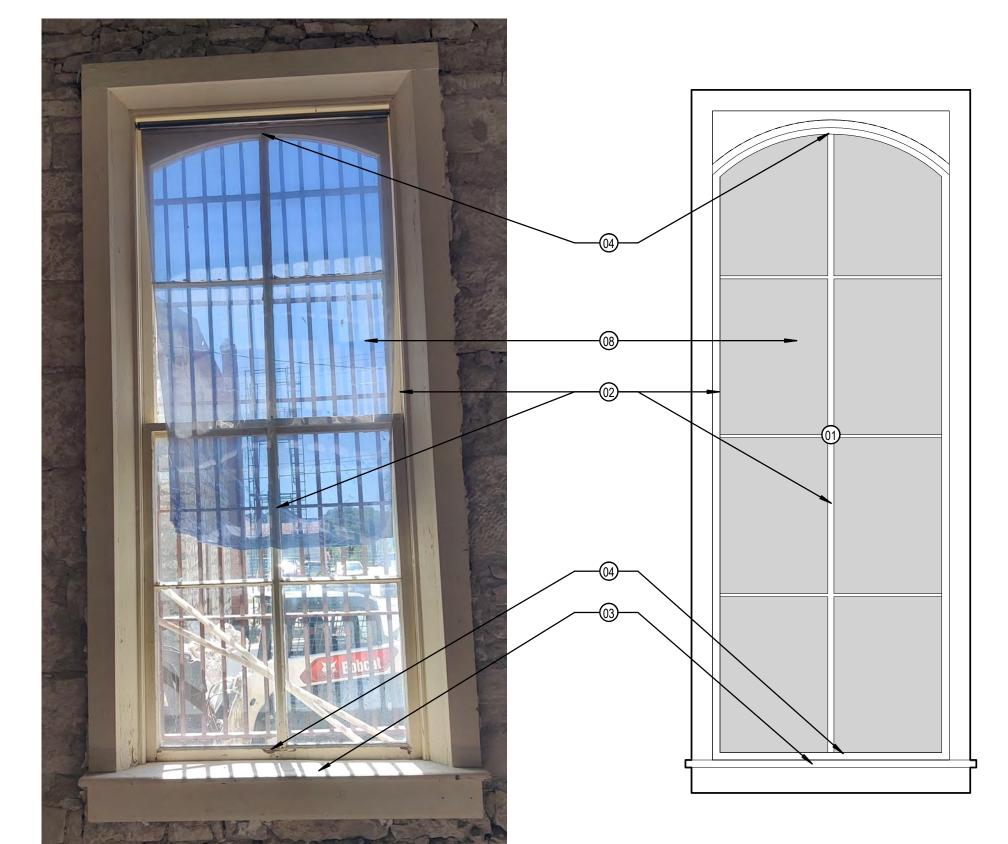
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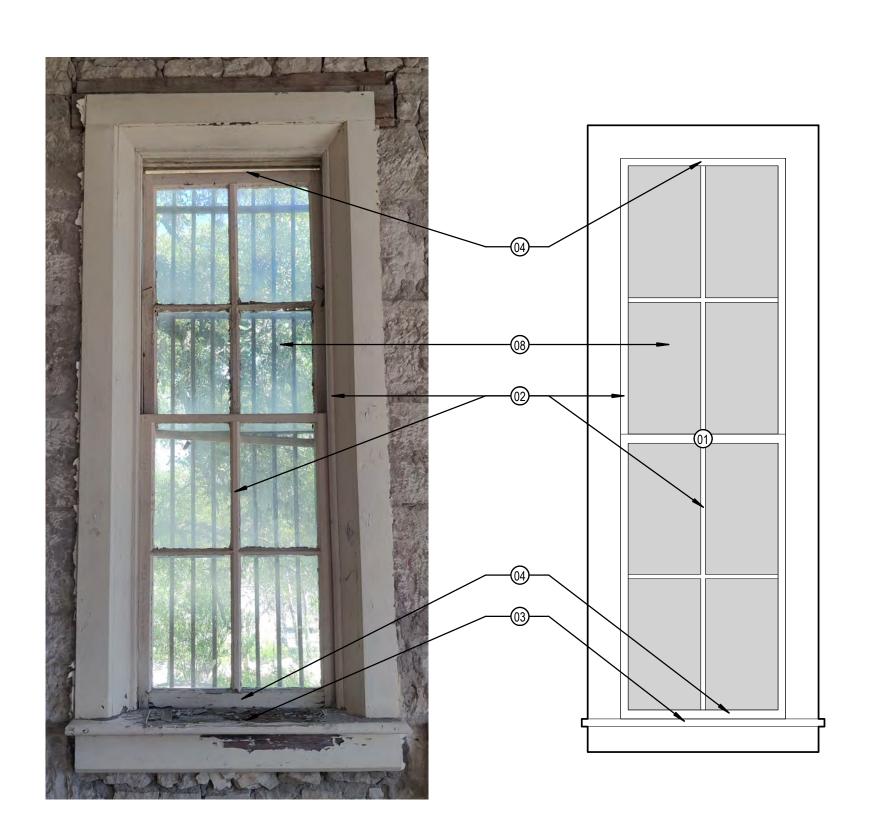


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JL-1 EXTERIOR

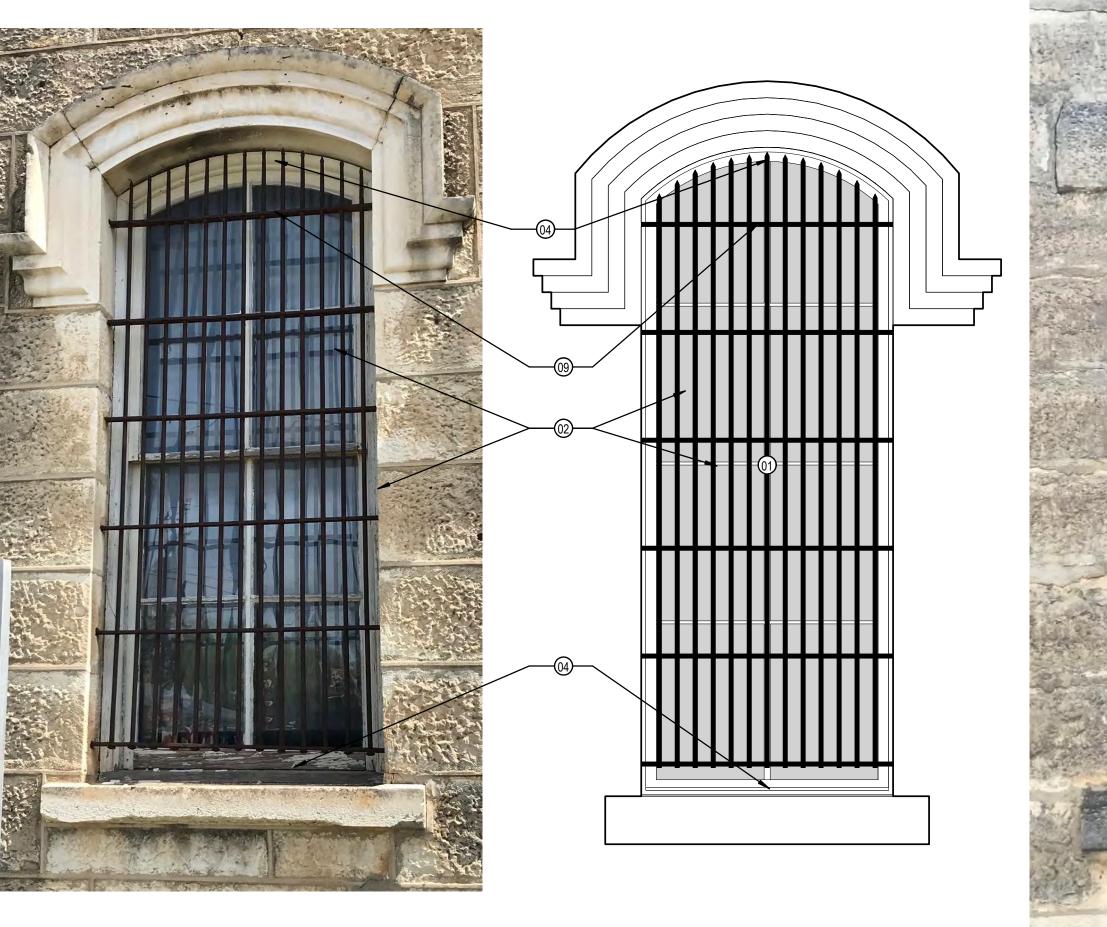



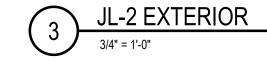

GENERAL NOTES

1. IMMEDIATELY ON DISCOVERY OF THE NEED FOR CLARIFICATION OF THE CONTRACT DOCUMENTS, SUBMIT A REQUEST FOR

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JAIL

881

DETAILS

REHABILITATION

SHEET TITLE: WINDOW

CENTER

COUNTY VISITOR

BANDERA


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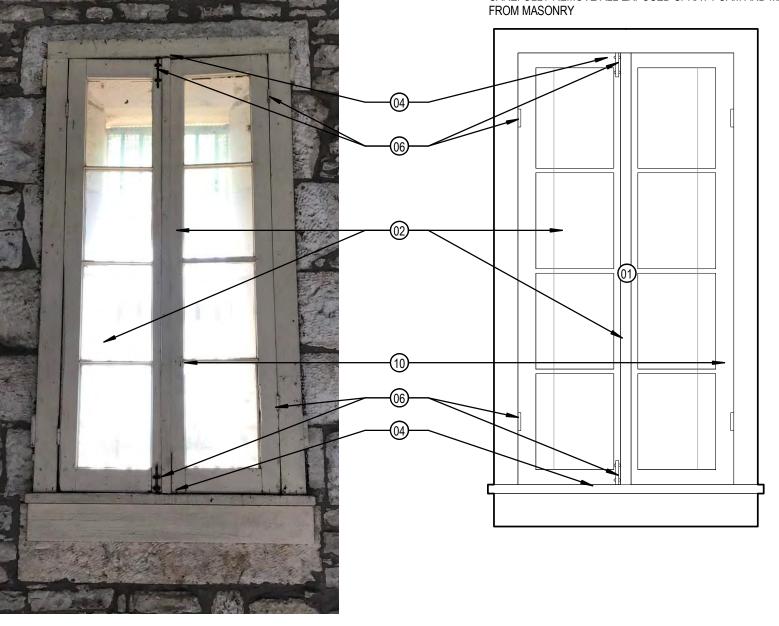
A REVISIONS DATE


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KEYNOTES


- 01 REPLACE ROTTED COMPONANTS WITHIN FRAME AS NEEDED WIT WOOD, IN-KIND, MATCHING SIZE, SPECIES, AND PROFILE. SAND, PREP, AND PAINT ALL WOOD SURFACES.
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- 17 NEW HARDWARE, MATCH EXISTING IN-KIND.
- DEMO PLYWOOD AND DUCT WORK TO REVEAL JAIL BARS;





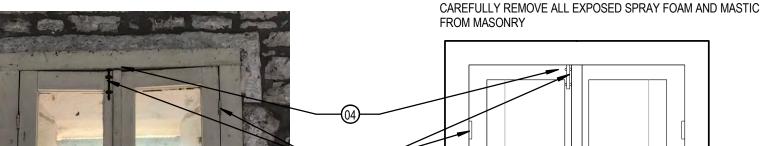

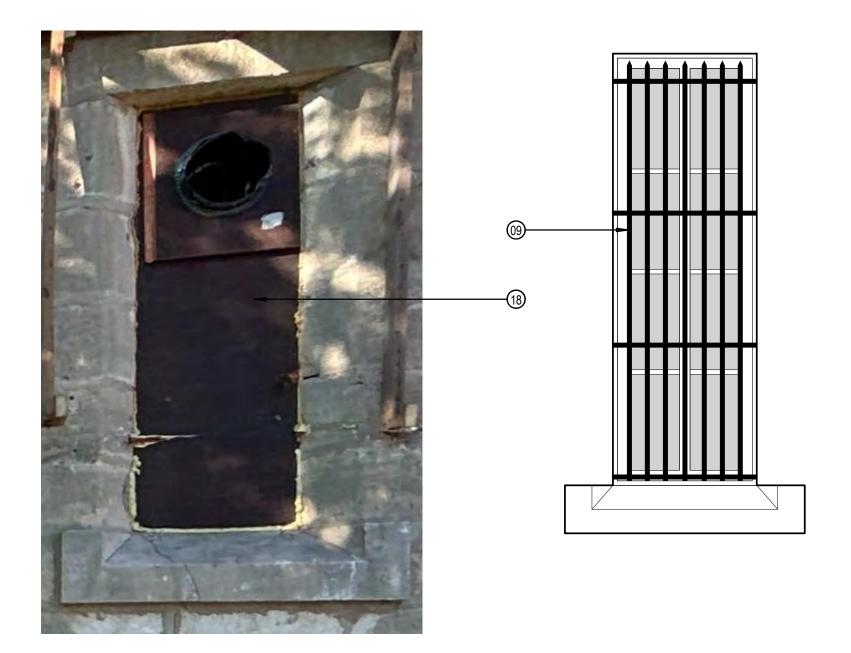TYPE B EXTERIOR

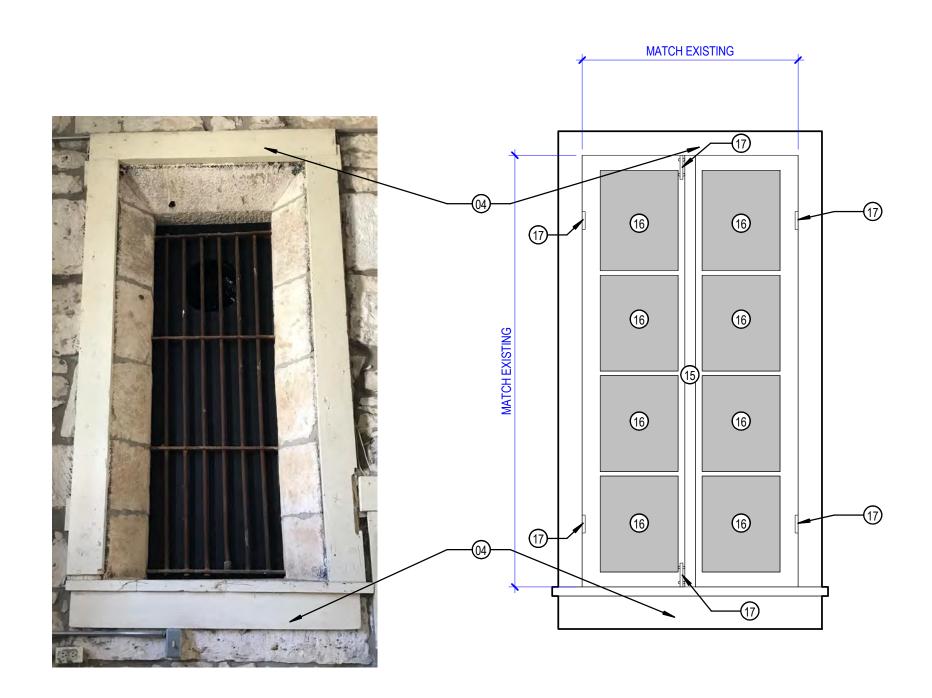


2 TYPE B INTERIOR

3/4" = 1'-0"


DOOR HARDWARE SET ALTERNATE

	HARDWARE	
NUMBER	SET	COMMENTS
C-100	LS-1	[1,2]
C-101	LS-1	[1,2]
C-102	LS-1	[1,2]
J-100	LS-2	[1,3]

	LEGEND	COMMENTS				
	HARDWARE TYPES	[1]	REPLACE EXISTING HARDWARE PER SCHEDULE			
	LS-1 : LOCKSET; REFER TO SPECS LS-2 : LOCKSET; REFER TO	[2]	PROVIDE MASTER KEY FOR ALL LS-1 HARDWARE			
	SPECS	[3]	PROVIDE MASTER KEY FOR ALL LS-2 HARDWARE			

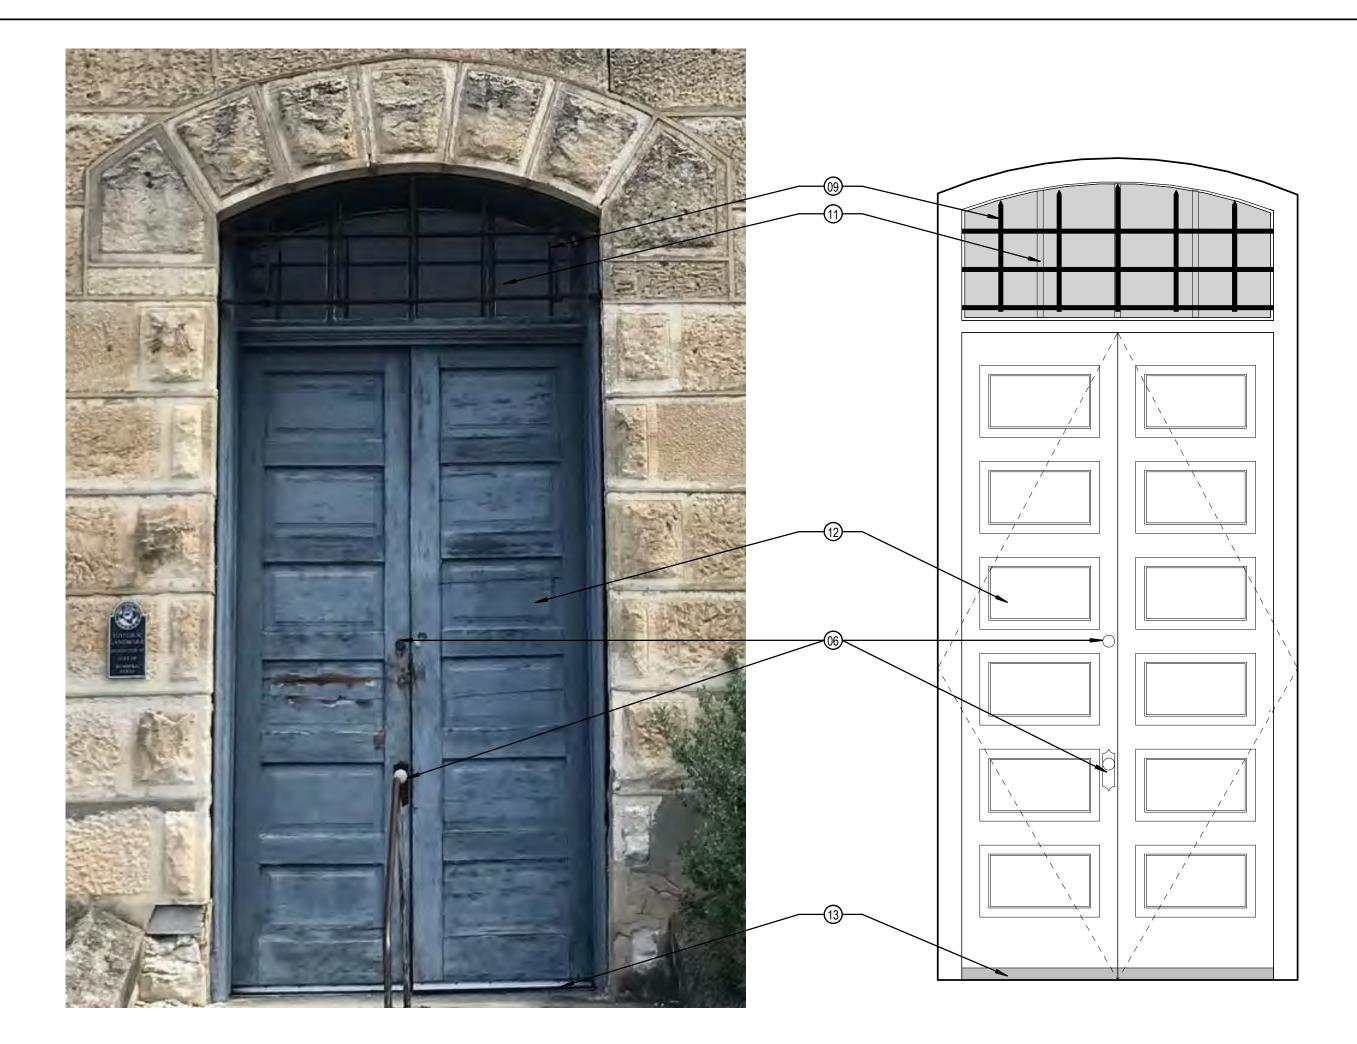

↑ DOOR J100 - EXTERIOR ELEVATION

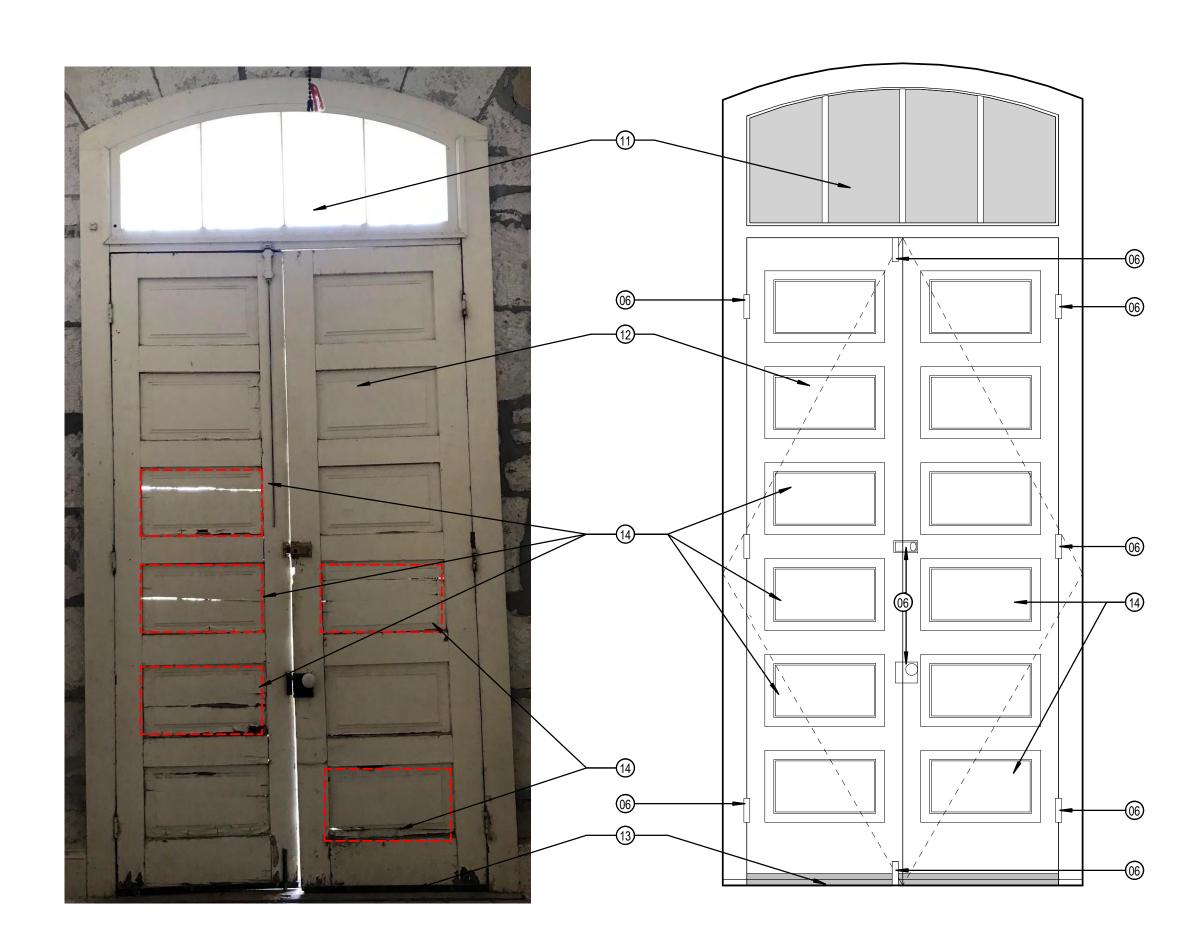

DOOR J100 - INTERIOR ELEVATION

3/4" = 1'-0"

GENERAL NOTES

- 1. IMMEDIATELY ON DISCOVERY OF THE NEED FOR CLARIFICATION OF THE CONTRACT DOCUMENTS, SUBMIT A REQUEST FOR
- INFORMATION TO ARCHITECT. 2. THESE DOCUMENTS SHOULD NO BE CONSIDERED AS A SURVEY OF EXISTING CONDITIONS. THE GENERAL CONTRACTOR SHALL NOTIFY ARCHITECT IMMEDIATELY OF ANY DISCREPANCIES OR

OMISSIONS BETWEEN DOCUMENTS AND FIELD CONDITIONS

- BEFORE COMMENCING ANY WORK AND REQUEST CLARIFICATION. 3. ELEMENTS NOTED WITHIN KEYNOTES ARE BASED UPON VISUAL OBSERVATIONS AT THE TIME OF SURVEY, CONTRACTOR TO VERIFY ANY ADDITIONAL SUBSEQUENT DAMAGE THAT MAY HAVE OCCURED. CONTRACTOR TO ASSUME 30% REPLACEMENT OF ELEMENTS IN-KIND FOR EACH WINDOW FOR PURPOSES OF BID AND VERIFY ON-SITE ANY ELEMENTS THAT ARE ROTTED, BROKEN SPLIT OR MISSING SHALL BE REPLACED IN-KIND.
- 4. FIELD VERIFY ALL EXISTING DIMENSIONS, ELEVATIONS, & CONDITIONS PRIOR TO COMMENCEMENT OF WORK.
- 5. ALL DIMENSIONS ARE TO FACE OF MATERIAL UNLESS NOTED 6. CHIPS OR GAPS IN WOOD UNDER ONE-INCH MAY BE REPAIRED
- WITH WOOD FILLER. SAND, PREP & PAINT TO MATCH. 7. ANY BROKEN PANES OF GLASS TO BE REPLACED & REGLAZED
- 8. APPLY A CONTINUOUS BEAD OF CLEAR SEALANT AROUND PERIMETER OF EACH WINDOW FRAME.

KEYNOTES

- 01 REPLACE ROTTED COMPONANTS WITHIN FRAME AS NEEDED WIT WOOD, IN-KIND, MATCHING SIZE, SPECIES, AND PROFILE. SAND, PREP, AND PAINT ALL WOOD SURFACES.
- 02 STRIP AND PREPARE STILES, MULLIONS, AND RAILS TO RECEIVE NEW COAT OF PAINT. PATCH/REPAIR CRACKS AND HOLES WITH PUTTY. ANY ROTTED COMPONENTS TO BE REPLACED WITH WOOD, IN-KIND, MATCHING SPECIES.
- 03 STRIP AND PREPARE CASING, STOOL, AND APRON TO RECEIVE NEW COAT OF PAINT TO MATCH EXISTING. PATCH/REPAIR CRACKS AND HOLES WITH PUTTY. ANY ROTTED COMPONENTS TO BE REPLACED WITH WOOD, IN-KIND, MATCHING SIZE AND
- 04 STRIP AND PREPARE WINDOW FRAMES, SILLS, SASHES, AND TRIM TO RECEIVE NEW PAINT. PATCH/REPAIR CRACKS AND HOLES WITH PUTTY. ANY ROTTED COMPONENTS TO BE REPLACED WITH WOOD, IN-KIND, MATCHING SIZE AND SPECIES.
- 05 REPAIR DAMAGED STILES.
- 06 STRIP AND RECONDITION HARDWARE FOR REUSE. REPLACE MISSING CASING WITH WOOD, IN-KIND, MATCHING SIZE
- 08 REPLACE BROKEN GLASS, REPLACE WITH NEW TEMPERED GLASS
- 09 SODA BLAST CLEAN ALL JAIL WINDOW BARS DOWN TO BARE METAL, THEN APPLY EPOXY PRIMER, THEN PAINT
- 10 STRIP AND PREPARE INTERIOR WINDOW SCREEN TO RECEIVE NEW PAINT. PATCH/REPAIR CRACKS AND HOLES WITH PUTTY. ANY ROTTED COMPONENTS TO BE REPLACED WITH WOOD, IN-KIND, MATCHING SIZE AND SPECIES. REPLACE GLASS PANES IN-KIND.
- REPAIR EXISTING TRANSOM FRAME / GLASS; REMOVE EXISTING PANES, REPLACE WITH NEW TEMPERED GLASS, IN-KIND. REPLACE DAMAGED WOOD COMPONANTS, IN-KIND, AS NEEDED. SAND, PREP, AND PAINT ALL WOOD SURFACES.
- 12 REPAIR / REPLACE DAMAGED DOOR COMPONENTS AS NEEDED WITH WOOD, IN-KIND, MATCHING SIZE AND SPECIES. SAND, PREP, AND PAINT ALL WOOD SURFACES.
- 13 REPLACE DAMAGED, DETERIORATED, OR MISSING WEATHERSTRIPPING AND INSTALL ADA METAL THRESHOLD.
- DAMAGED RECESSED PANELS TO BE REPLACED IN-KIND TO MATCH EXISTING IN SIZE AND SPECIES; SAND, PREP, AND PAINT NEW WOOD SURFACES TO MATCH EXISTING WOOD SURFACES
- 15 CONSTRUCT REPLICA WINDOW MATCH ADJACENT WOOD WINDOWS INKIND, SIZE AND SPECIES.
- 16 NEW TEMPERED GLASS, MATCH EXISTING IN-KIND.
- 17 NEW HARDWARE, MATCH EXISTING IN-KIND.
- DEMO PLYWOOD AND DUCT WORK TO REVEAL JAIL BARS; CAREFULLY REMOVE ALL EXPOSED SPRAY FOAM AND MASTIC

8/08/24

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REHABILITATION SHEET TITLE: DOOR

JAIL

%

DETAILS

CENTER

COUNTY VISITOR

BANDERA

PROJECT NO: 2301 A1

A REVISIONS DATE

SHEET NO: